## CITY OF BELMONT **RALSTON AVENUE CORRIDOR IMPROVEMENT PLAN SEGMENTS 1 AND 2**

#### SHEET INDEX

SHEET No. DESCRIPTION TITLE SHEET GENERAL NOTES AND LEGEND

#### SIGNING AND STRIPING PLAN

RALSTON AVE AND SOUTH RD & RALSTON AVE (6TH AVE TO EL CAMINO REAL) 6TH AVE AND EMMETT AVE & EL CAMINO REAL (EMMETT AVE TO RALSTON AVE) RALSTON AVE (OLD COUNTY RD TO GRANADA ST) MASONIC WAY (OLD COUNTY RD ST TO HILLER ST) MASONIC WAY (CLUC COUNTY RD ST TO HILLER ST)
RALSTON AVE (GRANADA ST TO US 101 SB OFF RAMP)
RALSTON AVE (US101 SB OFF RAMP TO US 101 NB ON RAMP)
RALSTON AVE (US101 NB OFF RAMP TO US 101 NB ON RAMP)

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EL CAMINO REAL AT ELMETT AVE SIGNING AND STRIPING

#### ELECTRICAL 16

#### ELECTRICAL DETAILS

## CIVIL IMPROVEMENTS PLAN

LEGENO & ABBREVIATIONS
KEY MAP
RALSTON AVENUE
RALSTON AVENUE
RALSTON AVENUE
RALSTON AVENUE
RALSTON AVENUE
GTH AVENUE
EMMETT AVENUE
EMMETT AVENUE
EMMETT AVENUE
EMMETT AVENUE EMMETT AVENUE
OLD COUNTY ROAD
MASONO WAY
MILLER STREET AND RALSTON AVENUE "SOUTH"
TIMIN PIRES PARK PATHAMY ALTERNATIVE 1 - REV. B
RALSTON AVENUE
PALSTON AVENUE
DETAILS
SECTION & DETAILS
SECTION & DETAILS
DETAILS
DETAILS



BEFORE EXCAVATING
CALL U.S.A.
UNDERGROUND SERVICE ALERT
800—227—2600
TWO WORKING DAYS BEFORE ALL
PLANNED WORK OPERATIONS









CORRIDOR IMPROVEMENT PLAN SEGMENTS 1 & 2

SHEET

TITLE

DEPARTMENT OF PUBLIC WORKS

- SIGNING AND STRIPTING SHALL CONFORM TO THE CITY OF MILLBRAE REQUIREMENTS. APPLICABLE DETAILS OF THE CALFORNIA DEPARTMENT OF TRANSFORTATION (CALTENAS) 2015 STRANDED PLANS, STRANDARD SPECIFICATIONS, LISTED EDITION OF THE CALFORNIA MUTCH, SIGN SPECIFICATIONS SHEETS, AND THE SPECIFICATIONS.
- ALL STRIPING SHALL BE THERIMOPLASTIC UNLESS OTHERWISE NOTED. ALL TRAFFIC STRIPES AND PAVEMENT MARKINGS SHALL BE APPLIED AT A THICKNESS OF 0.150 INCH.
- ALL CROSSWALK AND STOP BAR STRIPES SHALL BE 12" WHITE STRIPES UNLESS DIMERWISE NOTED ON THE PLANS. ALL CROSSWALKS SHALL BE 11" D.C. IN WIDTH.
- CONTRACTOR TO PROVIDE SIGN PROOFS TO CITY FOR APPROVAL PRIOR TO MANUFACTURING OF ANY PROPOSED SIGNS ON THIS PLAN.
- CONTRACTOR TO ADD PRIMER ON ROADWAY PRIOR TO INSTALLING ANY NEW THERMOPLASTIC STRIPING.

#### LEGEND

-

EXISTING SIGN TO REMAIN

INSTALL NEW THERMOPLASTIC STRIPING PER DETAIL NUMBER

EXISTING STRIPING TO REMAIN

## REMOVE EXISTING STRIPING

TYPE I ARROW PAVEMENT MARKING PER CALTRANS STD PLAN AZ4A

TYPE II (L) ARROW PAVEMENT MARKING PER CALTRANS STO PLAN A24B

TYPE III (L) ARROW PAVEMENT MARKING PER CALTRANS STD PLAN A248

TYPE N (L) AND (R) ARROW PAVEMENT MARKING PER CALTRANS STD PLAN 4245

TYPE VII (L) AND (R) ARROW PAVEMENT MARKING PER CALTRANS STD PLAN

"STOP" PAVEMENT MARKING PER CALTRANS STD PLAN A24D

"RIKE LANE SYMPOL" PAVEMENT MARKING LEGEND AND ARROW PER CALTRANS STD PLAN AZ4C

"SHARED ROADWAY BICYCLE" PAVEMENT MARKING PER CALTRANS STD PLAN A24C

XX\*(\overline{A}) (LENGTH OF DETAIL) STRIPING DETAIL

XX\*(TEX) (LENGTH OF DETAIL) EXISTING STRIPING DETAIL

CONFORM TO EXISTING

CHANGE IN STRIPING DETAIL

#### **GENERAL NOTES**

- THE CONTRACTOR AGREES THAT IN ACCORDANCE WITH GENERALLY ACCEPTED CONSTRUCTION PRACTICES, HE SHALL ASSUME SOLE AND COMPLETE RESPONSIBILITY FOR THE JOB SITE PROCTICES, HE SHALL ASSUME SOLE AND COMPLETE RESPONSIBILITY FOR THE JOB SHE CONCINIONS DIMING THE COURSE OF CONSTRUCTION THE PROPERTY, INCLINION ASSUMED AND CONCINIONS DIMING THE CONTRIBUTION OF THE SHALL DEFEND, NOT BE LIMITED TO HORMAL WORKING HOURS AND THAT THE CONTRIBUTION SHALL DEFEND, NOT BE LIMITED TO HORMAL WORKING HOURS AND THAT THE CONTRIBUTION SHALL DEFEND, NOT BE LIMITED TO HORMAL WORKING AND THE CONTRIBUTION OF THE STATE REGISTERING FOR THE CONTRIBUTION OF THE SOLE REGISTERING FOR THE CONTRIBUTION OF TH
- 2. THE ENGINEER ASSUMES NO RESPONSIBILITY BEYOND THE ADEQUACY OF THE DESIGN CONTAINED HEREIN.
- THE CONTRACTOR SHALL COMPLY WITH THE RULES AND REGULATIONS OF THE CAL/OSHA STATE OF CALIFORNIA CONSTRUCTION SAFETY ORDERS.
- 4. SHOULD IT APPEAR THAT THE WORK TO BE DONE, OR ANY MATTER RELATIVE THERETO, IS NOT SUFFICIENTLY DETAILED OR EXPLAINED ON THESE PLANS THE CONTRACTOR SHALL CONTACT THE ENGINEER FOR SUCH FURTHER EXPLANATIONS AS MAY BE NECESSARY
- 5. ALL WORK SHALL CONFORM TO THE CURRENT CITY OF BELMONT ORDINANCES (UNIFORM CONSTRUCTION STANDARDS] AND THE STANDARD SPECIFICATIONS OF THE CITY OF BELMONT AND THE STATE OF CALIFORNIA
- 6. THE CONTRACTOR SHALL SUBMIT TO THE CITY AND HAVE IN THE SUPERINTENDENT'S VEHICLE. EMERGENCY TELEPHONE NUMBERS FOR POLICE, FIRE, AMBULANCE, AND THOSE AGENCIES RESPONSIBLE FOR MAINTENANCE OF UTILITIES IN THE VICINITY OF THE JOB SITE.
- 7. EMERGENCY PHONE NUMBERS TO REACH CONTRACTOR SHALL BE GIVEN TO CITY OF BELMONT
- 8. THE CONTRACTOR SHALL PROVIDE ALL LIGHTS, SKONS, BARRICADES, FLAGMEN OR OTHER DEVICES NECESSARY TO PROVIDE FOR PUBLIC SAFETY.
- 9. EXCAVATIONS SHALL BE ADEQUATELY SHORED, BRACED AND SHEETED SO THAT THE EARTH-WILL NOT SLIDE OR SETTLE AND SO THAT ALL EXISTING INFROVEMENTS OF ANY NOND WILL BE FILLY PROTECTED FROW DAMAGE. ANY DAMAGE RESULTING FROM A LACK OF ADEQUATE SHORING, BRACING AND SHEETING SHALL BE THE RESPONSIBILITY OF THE CONTRACTOR AND. HE SHALL AFFECT NECESSARY REPAIRS OR RECONSTRUCTION AT HIS OWN EXPENSE. WHERE THE SMALL AFFECT INCESSARY REPAIRS OF RECOMSTRUCTION AT HIS OTHER EXPENSE. THE EXCANDATION FOR A COMBUILT TRENCH AND/OR STRUCTURE IS FIVE FEET OR MORE IN DEPTH, THE CONTRACTOR SHALL PROVIDE ADEQUATE SHEETING, SHORING AND BRACING OR EQUIVALENT METHOD FOR THE PROTECTION OF LIFE OR LIMB, CONFORMING TO THE APPLICABLE CONSTRUCTION SAFETY OF THE DIAGNOT OF INDUSTRALL SAFETY OF THE STATE OF CALIFORNIA. THE CONTRACTOR SHALL ALWAYS COMPLY WITH OSHA REQUIREMENTS
- ALL WORK SHALL BE PERFORMED IN CONJUNCTION WITH PROJECT SPECIFICATIONS AND SPECIAL PROVISIONS.
- 11.NO WORK SHALL BE DONE ON THIS PROJECT PRIOR TO A PRE-CONSTRUCTION CONFERENCE TO BE HELD WITH THE PUBLIC WORKS DEPARTMENT AND ENGINEER
- 12.EQUIPMENT SHALL NOT BE STORED ON OR WITHIN THE PUBLIC RIGHT-OF-WAY WITHOUT PRIOR WRITTEN APPROVAL FROM THE CITY ENGINEER. IF PERMITTED, COUIPMENT SHALL BE SECURED AND LOCKED WITH PROTECTIVE COVERS IN PLACE. ADEQUATE BARRICADES WITH OFFICIALS FLASHERS SHALL BE INSTALLED AROUND THE COUPMENT AND REMAIN IN WORKING
- 13.THE CONTRACTOR SHALL INFORM THE CITY ENGINEER 48 HOURS IN ADVANCE OF THE TIME HE REQUIRES AN INSPECTOR, INCLUDING FORM WORK REVIEW AND APPROVAL.
- 14 THE FOLLOWING CONTROL MEASURES FOR GRADING AND CONSTRUCTION ACTIVITIES SHALL BE
  - A. GRADING AND CONSTRUCTION ACTIVITIES SHALL BE LIMITED TO THE HOURS OF 8 AM TO 5 PM ON WEEKOAYS; THERE SHALL BE NO GRADING OR CONSTRUCTION ACTIVITIES ON THE WEEKENDS OR CITY HOLIDAYS.
  - B. GRADING AND CONSTRUCTION EQUIPMENT SHALL BE PROPERLY MUFFLED.

  - D. NOISE-GENERATING STATIONARY CONSTRUCTION EQUIPMENT. SUCH AS COMPRESSORS. SHALL BE LOCATED AS FAR AS PRACTICAL FROM OCCUPIED RESIDENTIAL HOMES.
  - E. CONSTRUCTION TRASH AND DEBRIS SHALL BE CLEANED UP DAILY.
  - F. ALL UNPAVED ACCESS ROADS, PARKING AREAS AND CONSTRUCTION STAGING AREAS SHALL BE WATERED OR TREATED WITH (NON-TOXIC) SOIL STABILIZERS, AS NECESSARY
  - G, CONSTRUCTION SITES SHALL BE KEPT CLEAN AT ALL TIMES. AT NO TIME SHALL THE CONTRACTOR OR PERMIT HOLDER BE ALLOWED TO LEAVE THE SITE PRIOR TO THOROUGHLY CLEANING SIDEWALKS, CURBS, GUTTERS, AND STREET SURFACES.
  - H. ADJACENT STREETS & APPROVED HAUL ROUTES SHALL BE SWEPT DAILY BY MECHANICAL SWEPPERS EQUIPPED WITH VACUUM UNITS AND THOROUGHLY FLUSHED AFTER SWEPTING IS CONFLETED.
  - I. CONSTRUCTION ACTIVITIES SHALL COMPLY WITH CITY OF THE BELMONT NOISE
  - J. CONSTRUCTION ACCESS ROUTES SHALL BE APPROVED IN ADVANCE BY THE CITY OF
  - K. CONSTRUCTION TRAILERS AND STORAGE AREAS FOR CONSTRUCTION MATERIALS SHALL NOT BE LOCATED IMMEDIATELY CONTIGUOUS TO A NEIGHBORING RESIDENCE OR WITHIN THE PUBLIC RIGHT-OF-WAY.

- 15. PRIOR TO ISSUANCE OF A GRADING PERMIT, THE CONTRACTOR SHALL PREPARE A DUST CONTROL PLAN FOR SUBMITLA TO THE PUBLIC WORKS DEPARTMENT. THE DUST CONTROL PLAN SHALL INCLUSE A SCHEDULE FOR WATERING AREAS OF EXPOSED SURFACES DURING THE CONSTRUCTION AND GRADING PROCESS (EARLY MORNING AND EARLY EVENING).

  OVERFILLING OF WATER TRUCKS WILL NOT BE ALLOWED.
- 16. ALL CONSTRUCTION ACTIVITIES SHALL MEET THE REQUIREMENTS OF THE CITY OF BELMONT
- EROSION CONTROL MEASURES SHALL BE INSTALLED AS NECESSARY TO PREVENT SEDIMENT RUNOFF TO PUBLIC ROADWAYS, DRAINAGE FACILITIES AND ADJACENT PROPERTIES.
- 18. THE CONTRACTOR SHALL BE RESPONSIBLE FOR ANY DAMAGE TO THE SITE OR SURROUNDING AREA DUE TO DUST OR EROSION, RESULTING FROM WORK DONE BY THE CONTRACTOR. CONTRACTOR SHALL PROVIDE A SEVEN (7) DAY PHONE NUMBER TO RECEIVE AND RESPOND TO DUST COMPLAINTS RESULTING FROM ALL CONSTRUCTION OPERATIONS AND SHALL BE MAINTAINED UNTIL CONSTRUCTION IS COMPLETE.
- PRIOR TO ISSUANCE OF A GRADING PERMIT, CONTRACTOR SHALL PROVIDE A TRAFFIC CONTROL PLAN FOR REVIEW TO THE PUBLIC WORKS DEPARTMENT.
- 20. EXISTING UNDERGROUND UTILITIES AND IMPROVEMENTS ARE APPROXIMATE LOCATIONS BASED UPON RECORD INFORMATION AVAILABLE TO THE ENGINEER AT THE TIME OF PREPARATION OF OF THE SUM INFORMATION ANALOSES TO JUTE CHARGEST AT THE SILE OF THE STATE OF THE ST INDERGROUND SERVICE ALERT (800) 642-2444 TWO WORKING DAYS PRIOR TO START OF
- 21. AT THE TIME OF CONSTRUCTION ALL EXISTING MONUMENTATION, INCLUDING PROJECT SURVEY CONTROL POINTS, SHALL BE PRESERVED. IF MONUMENTS BECOME DAMAGED DURING CONSTRUCTION, THEY SHALL BE RESTORED AT THE CONTRACTORS EXPENSE.
- 22. STATIONING HEREON IS ALONG STREET CENTERLINE UNLESS OTHERWISE SHOWN OR
- 23. ALL RETURN RADII AND CURB DATA ARE TO FACE OF CURB.
- 24. ALL LENGTHS ARE BASED ON HORIZONTAL MEASUREMENTS
- 25. STATION AND OFFSET PROVIDED TO STORM DRAIN INLETS IS AT CENTER OF STRUCTURE AT FACE OF CURB.
- 26. THE CONTRACTOR SHALL IMMEDIATELY REPORT ANY SOIL OR WATER CONTAMINATION NOTICED DURING CONSTRUCTION TO THE CITY OF BELIMON! FIRE DEPARTMENT HAZANDOUS MICERALS DIVISION, HE SAN MATCO COUNTY DEPARTMENT OF HEALTH, AND THE CALIFORNIA REGIONAL
- ALL CURB, GUTTER, SIDEWALK & PAVEMENT TO BE REMOVED SHALL BE SAWCUT AT THE CONFORM LIMITS. ALL EXCAVATIONS INTO EXISTING PAVEMENTS SHALL BE SAWCUT.
- 28. ALL EXCAVATIONS SHALL BE BACKFILLED AND COMPACTED AT DAY'S END. A MINIMUM OF TWO INCHES OF TEMPORARY PANING SHALL BE INSTALLED AND COMPACTED BY MECHANICAL MEANS TO PRODUCE A SMOOTH SURFACE FOR PEDESTRAM AND VEHICULAR TRAFFLO
- 29. THE CONTRACTOR SHALL BE RESPONSIBLE FOR MATCHING STREETS, SURROLINDING LANDSCAPE AND OTHER IMPROVEMENTS WITH A SMOOTH TRANSITION IN PARMIC, CURBS, GUTTERS, SIDEMALKS, GRADING, TO AVOID ANY BRILIPT OR APPARENT CHANGES IN GRADES OR CROSS SLOPE, LOW SPOTS OR HAZARDOUS CONDITIONS. PARMIC CONFORMS SHALL BE WADE AT A SMOOTHLY TRIMMED BUTT JOINT. DO NOT OVERLAP EXISTING PAVEMENT.
- 30. IT IS THE PAYING CONTRACTOR'S RESPONSIBILITY TO RESTORE STREET AND SIDEWALK SUBGRADES DISTURBED DURING UNDERGROUND CONSTRUCTION. ALL EXISTING STREET IMPROVEMENTS DAMAGED DURING CONSTRUCTION SHALL BE REPAIRED TO THE SATISFACTION
- 31. ALL EXISTING UTILITIES AND IMPROVEMENTS THAT BECOME DAMAGED DURING CONSTRUCTION SHALL BE COMPLETELY RESTORED TO THE SATISFACTION OF THE CITY ENGINEER AND THE UTILITY OWNER, AT THE CONTRACTOR'S SOLE EXPENSE.
- 32. ALL MANHOLES, VALVE COVER, UTILITY BOXES, AND MONUMENT COVERS SHALL BE ADJUSTED TO FINISHED GRADE AFTER FINAL PAVING.
- 33. IF ARCHEOLOGICAL MATERIAL ARE UNCOVERED DURING GRADING, TRENCHING OR OTHER EXCAVATIONS, EARTHWORK WITHIN 100 FEET OF THESE MATERIALS SHALL BE STOPPED UNTIL A PROFESSIONAL ARCHAEOLOGIST WHO IS VERIFIED BY THE SOCIETY OF CALIFORNIA ARCHAEOLOGY (SCA) AND/OR THE SOCIETY OF PROFESSIONAL ARCHAEOLOGY (SOPA) HAS HAD AN OPPOPRIUNTY TO EVALUATE THE SIGNIFICANCE OF THE FIND AND SUGGESTS APPROPRIATE MITIGATION MEASURES, IF THEY ARE DEEMED NECESSARY.

#### **GRADING NOTES**

- PRIOR TO PERFORMING ANY GRADING, THE CONTRACTOR SHALL OBTAIN A GRADING PERMIT FROM THE CITY IN ACCORDANCE WITH THE MUNICIPAL CODE.
- 2. A REPRESENTATIVE OF THE SOILS ENGINEER SHALL BE ON SITE DURING GRADING.
- THE SOILS ENGINEER SHALL BE NOTIFIED AT LEAST TWO (2) WORKING DAYS PRIOR TO ANY GRADING OPERATIONS.
- ALL GRADING WORK SHALL BE INSPECTED AND APPROVED BY THE SOILS ENGINEER. ANY UNACCEPTED WORK SHALL BE CORRECTED A THE CONTRACTORS EXPENSE.
- IMPORT MATERIAL SHOULD BE APPROVED BY THE SOIL ENGINEER'S REQUIREMENTS BEFORE IT IS BROUGHT TO THE SITE.
- ALL EXCAVATION SPOILS SHALL BE DISPOSED OF IN ACCORDANCE WITH CALTRANS STANDARD SPECIFICATION SECTION 7-1.13 DISPOSAL OF MATERIAL OUTSIDE THE RIGHT OF WAY.
- 7. THE CONTRACTOR IS RESPONSIBLE FOR ALL ASPECTS OF EROSION, SEDIMENTATION &

#### **EROSION CONTROL NOTES**

- CONTRACTOR TO EMPLOY BEST MANAGEMENT PRACTICES (BMP'S) IN ACCORDANCE WITH THE LATEST EDITION OF THE STATE OF CALIFORNIA CONSTRUCTION SITE BMP MANUAL AND THE SAN MARCE STORMMATER POLLUTION PREVENTION PROGRAM.
- ALL LOOSE SOIL AND DEBRIS SHALL BE REMOVED FROM THE STREET AREAS LIPON STARTING OPERATIONS AND NO LESS OFTEN THAN DAILY THEREAFTER. INSPECTOR MAY REQUIRE MORE FREQUENT CLEANING AS WEATHER CONDITIONS DICTATE.
- EROSION CONTROL MEASURES SHALL BE INSTALLED AS NECESSARY TO PREVENT SEDIMENT RUNOFF TO PUBLIC ROADWAY DRAINAGE FACILITIES, ADJACENT PROPERTIES AND THE SAN
- ALL PAVED AREAS WILL BE KEPT CLEAR OF EARTHEN MATERIAL AND DEBRIS. THE SITE WILL BE MAINTINNED SO THAT SEDIMENT-LADEN RUNOFF DOES NOT ENTER THE STORM DRAINAGE SYSTEM.
- ALL STORM DRAIN STRUCTURES AND INLET PIPES SHALL BE PROTECTED FROM INFLOW OR SILT BY GRAVEL BAG SILT BARRIERS OR SIMILAR DEVICE.
- CONTRACTOR SHALL HAVE TOOLS, EQUIPMENT, AND MATERIALS TO PROVIDE EROSION CONTROL MEASURES MADE RECESSARY BY A CONSTRUCTION OPERATION, ON THE JOB SITE BEFORE BEGINNING THAT OPERATION.
- 7. ADJACENT PROPERTIES SHALL BE PROTECTED FROM STORM WATERS, MUD. SILT. ETC. ON A
- 8. DUST CONTROL SHALL BE MAINTAINED AT ALL TIMES DURING CONSTRUCTION AND UNTIL FINAL COMPLETION, THE CONTRACTOR WHEN HE OR HIS SUBCONTRACTOR ARE OPERATING EQUIPMENT ON-SITE, SHALL PREVENT THE FORMATION OF ANY ARRONNE NUISANCE BY ENDIFICATION CON-SIDE, STRUCK PREVENT THE FUNDATION OF ANY AMERICING MUSISANCE BY WATERING AND/OF TREATING THE SETS OF THE WORK IN SUCH A MANNER THAT WILL CONTINE DUST PARTICLES TO THE IMMEDIATE SURPINCE OF THE WORK. ADDITIONAL WATERING SHALL BE PROVIDED ON BY OR WINDY JOANS. THE CONTINETOR WILL BE RESPONSIBLE FOR ANY DANGE CAUSED BY DUST FROM HIS OWN ACTIVITIES OF HIS SUBCONTRACTIONS ACTURIES IN PERFORMING THE WORK LUMBER THIS CONTRACT AND SHALL SUBCONTRACTIONS CONTRACT AND SHALL BE RESPONSIBLE FOR ANY CITATIONS, FINES, OR CHARGES RESULTING FROM DUST NUISANCE. DUST CONTROL WILL BE DONE ON A DAILY BASIS
- CONCRETE WASH AREA SHALL BE CONSTRUCTED IN ACCORDANCE WITH CALIFORNIA STORM WATER BEST MANAGEMENT PRACTICES DETAIL WIN-8.
- 10. STORE, HANDLE AND DISPOSE OF CONSTRUCTION MATERIALS AND WASTES SO AS TO PREVENT THEIR ENTRY TO THE STORM DRAIN SYSTEM. CONTRACTOR MUST NOT ALLOW CONCRETE, WASH WATERS, SLURRIES, PAINT OR OTHER MATERIALS TO ENTER CATCH BASINS OR TO ENTER SITE RUNDEY.
- 11. USE FILTRATION OR OTHER MEASURES TO REMOVE SEDIMENTS FROM DEWATERING EFFLUENT
- NO CLEANING, FUELING, OR MAINTAINING VEHICLES ON SITE SHALL BE PERMITTED TO ALLOW DELETERIOUS MATERIALS FROM ENTERING CATCH BASINS OR TO ENTER SITE RUNOFF.

CV2 28 \_ SECMENTS

By: AM

SND

LEGI

AND

ES

NOT

GENERAL

PUBI PLAN Q. IMPROVEMENT DEPARTMENT


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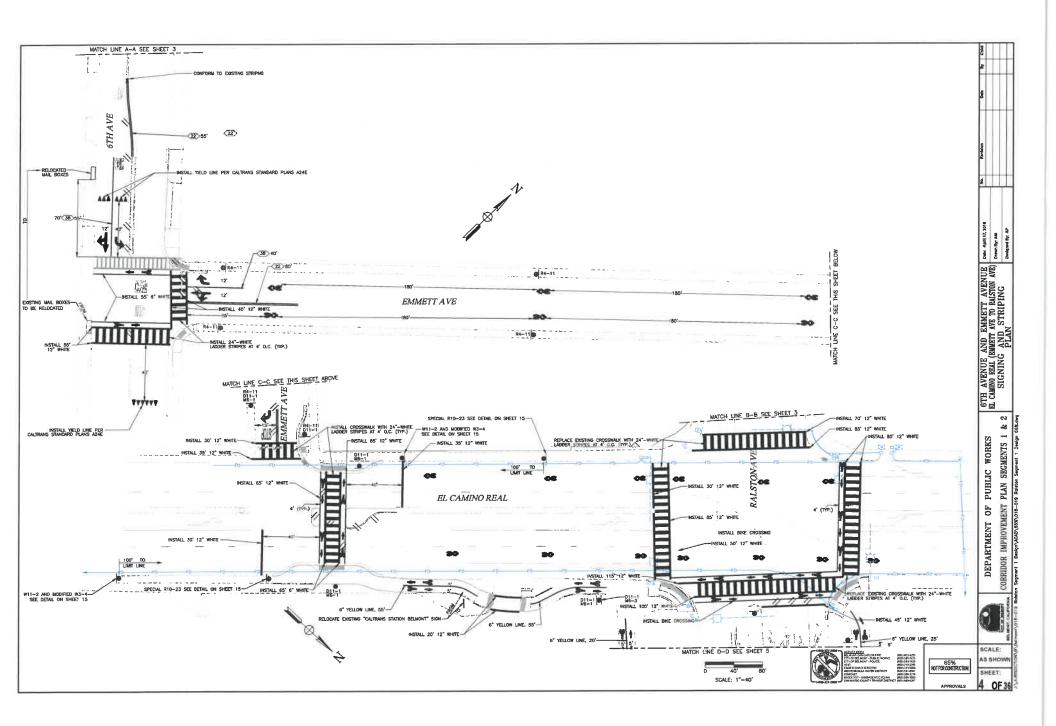



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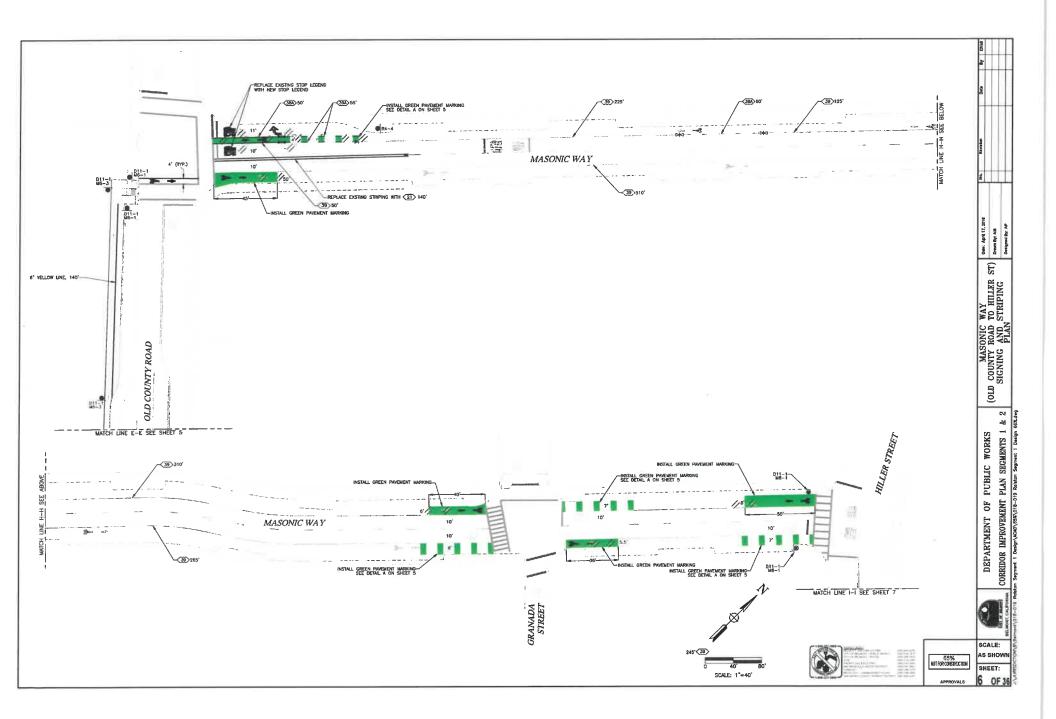
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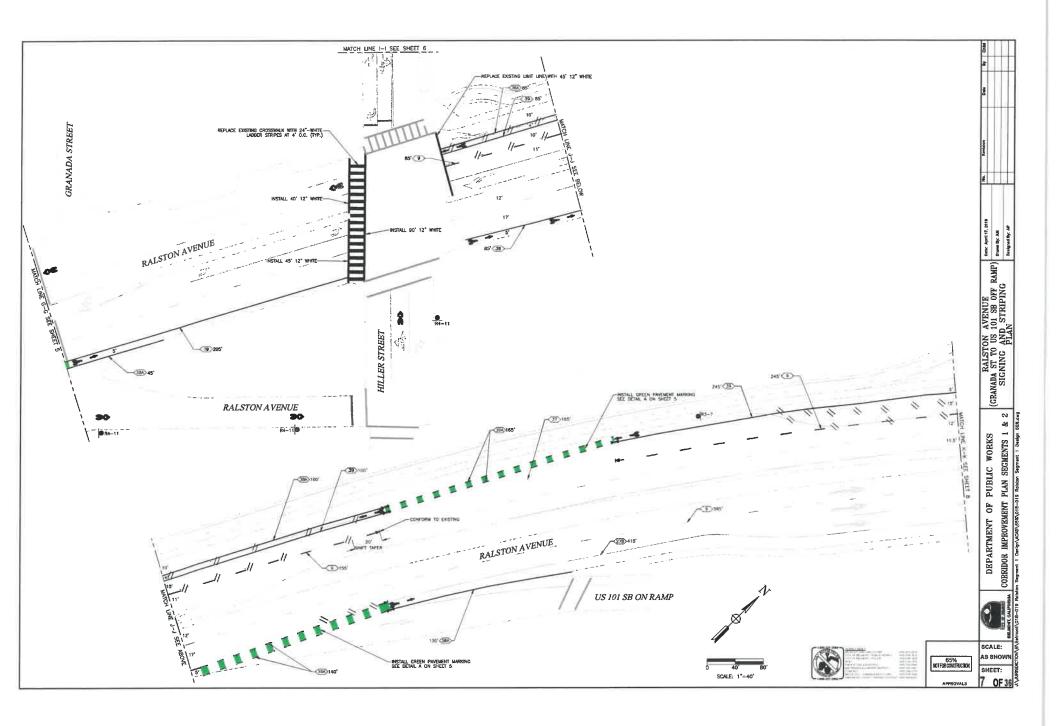
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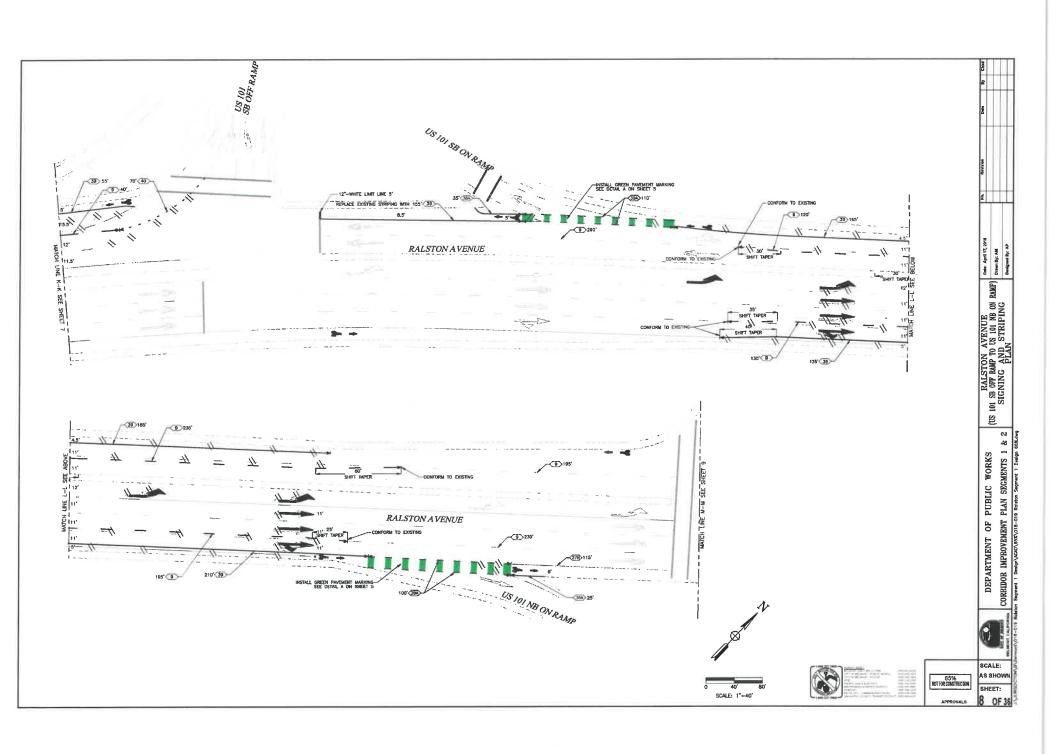










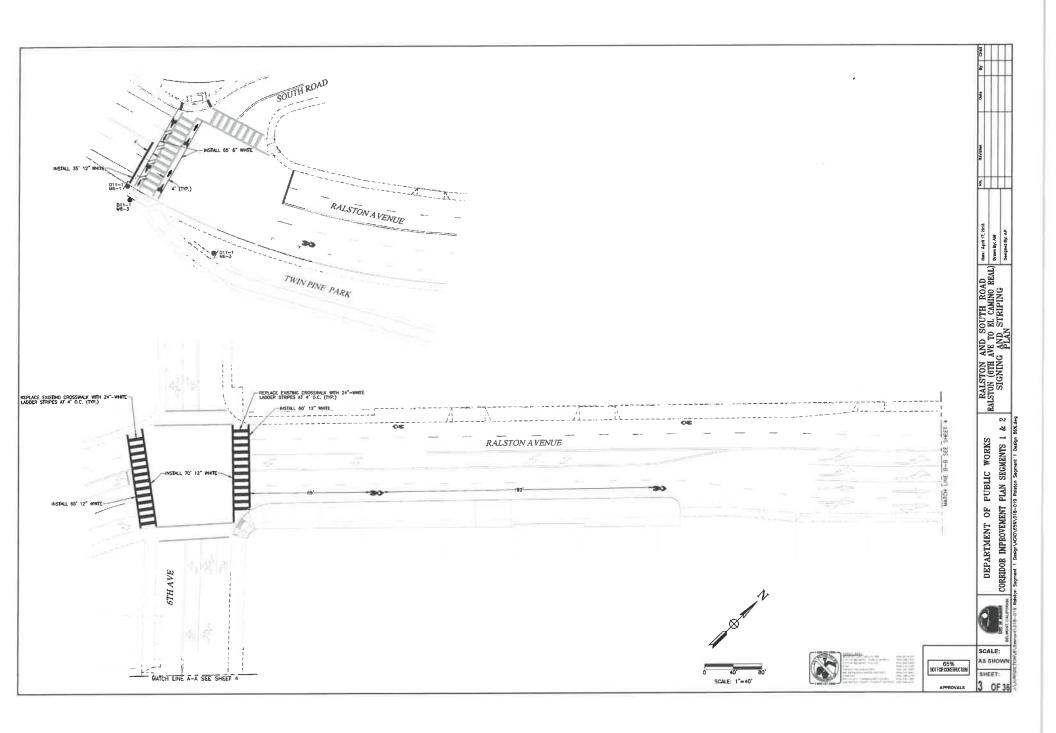

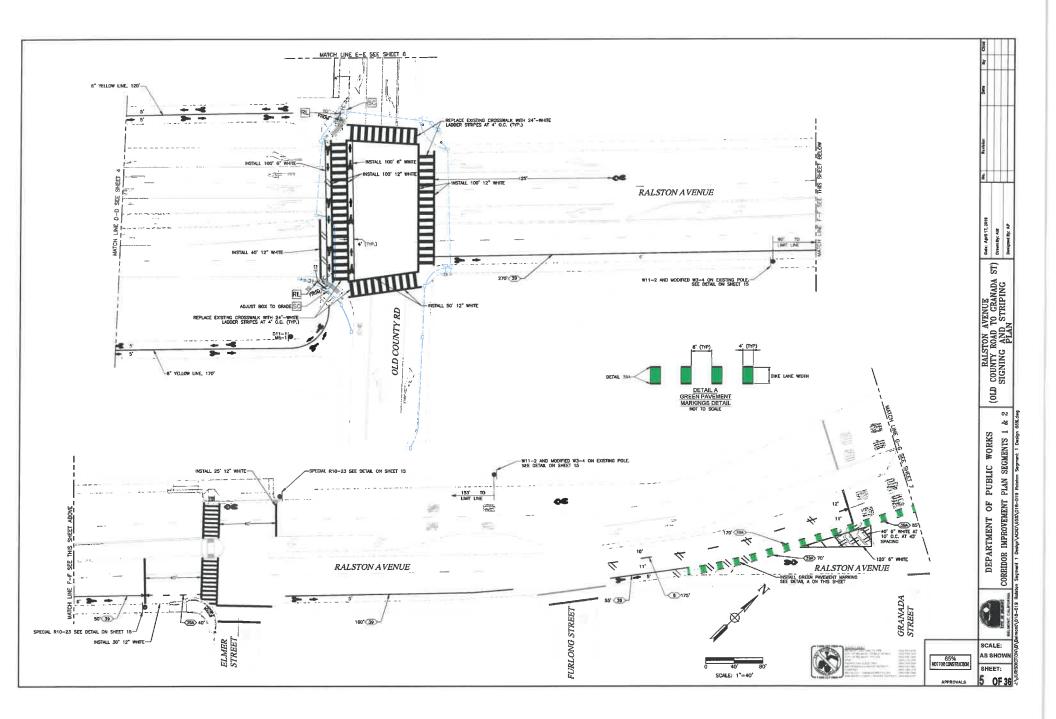


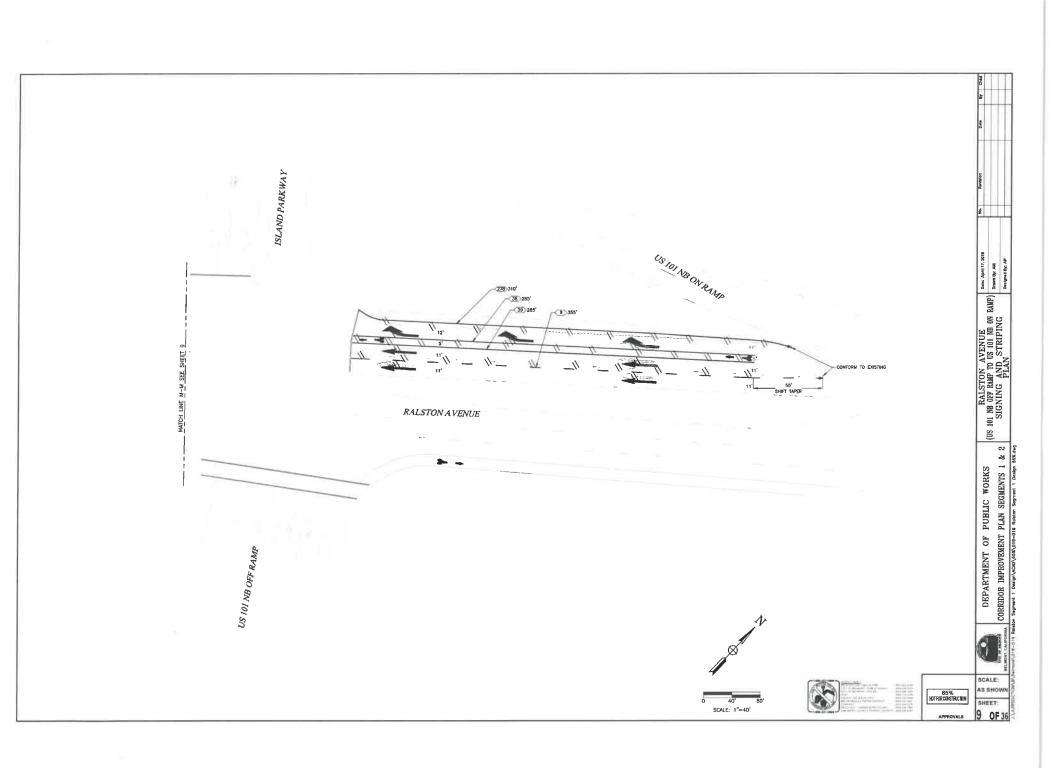

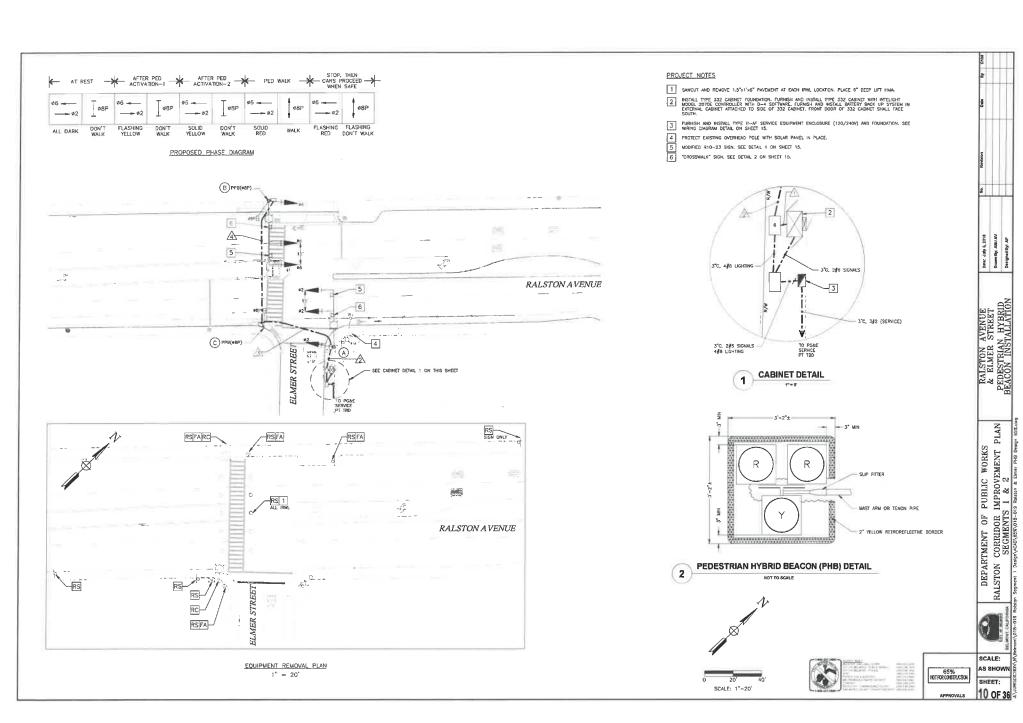

		NUMBER OF CONDUCTORS						
AWG OR CABLE	CONDUIT RUN	CONDUIT RUN NUMBERS						
CABLE		$\triangle$	2	3	4			
	02	3	3					
	ø6	3	3	3	3			
	@8P	2	2	2	2			
#14	Ø8PPB	1	1	- 1	- 1			
	PPB COMMON	1	1	1	1			
	SPARES	3	3	3	3			
	TOTAL #14	13	13	10	10			
	LUMINAIRES		2	2	2			
	SIGNAL COMMON		1	1	1			
#8	BOND (BARE)		- 1	- 1	1			
	TOTAL #8		4	4	4			
	CONDUIT SIZE (in)	3*	3"	3*	3"			
	% CONDUIT FILL	4%	7%	6%	6%			

STANDARD NOTES AND ABBREVIATIONS: = NEW CONDUIT RUN

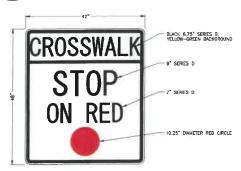





- SIGN SHALL BE DOUBLE FACED USING 8 INCH UPPERCASE SERIES D LETTERS CENTERED VERTICALLY.
- SION SHALL BE A D3-1 PLATE WITH 3/4 INCH BLACK BORDER AND BLACK LETTERING ON YELLOW-CREEN, RETROREFLECTIVE, BACKGROUND (TYPE IX RETROREFLECTIVE SHEETING) CONSTRUCTED USING O.00 INCH GAUGE WETA, ELATE.
- MAST ARM MOUNTED STREET NAME SIGNS SHALL BE INSTALLED WITH OVERHEAD MAST ARM ADJUSTABLE SWING SIGN BRACKETS (HAWKINS MIOJ-OC825CAL).
- REFER TO CALTRANS STANDARD PLANS FOR MOUNTING DETAILS AND PLACEMENT. THE SIGN BRACKET SMALL BE DOUBLE STRAPPED TO THE WAST ARM WITH HEAVY DUTY STAINLESS STEAD STRAPS.
- PROVIDE CITY WILL FULL SIZE PAPER PRINT OF SIGN TO REVIEW AND APPROVE PRIOR TO MANUFACTURING THE SIGN.



MAST ARM MOUNTED "CROSSWALK" SIGN


NOT TO SCALE



STANDARD NOTES:

OTHER REQUIREMENTS ARE COVERED BY NOTES, LEGENDS, SPECIAL PROVISIONS AND STANDARD SPECIFICATIONS, SIGNAL & LIGHTING STANDARDS SHALL CONFORM TO THE MOST RECENT PROVISIONS OF THE CALTRANS STANDARD PLANS, ALL EQUIPMENT SHOWN IN THE SCHEDULE IS NEW UNLESS NOTED OTHERWISE WITH AN (E).

(X) = NEW SIGNAL POLE

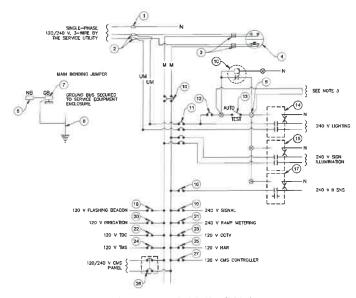

120/240 V SERVICE WIRING DIAGRAM (TYPICAL)

- 1. VOLTAGE RATINGS OF SERVICE EQUIPMENT SHALL CONFORM TO THE SERVICE VOLTAGES INDICATED ON THE PLANS
- 2. UNLESS OTHERWISE INDICATED ON THE PLANS, SERVICE EQUIPMENT ITEMS SHALL BE PROVIDED FOR EACH SERVICE EQUIPMENT ENCLOSURE AS SHOWN.
- COMMENT OF REMOTE THE SHIPLY MOUNTED ON LIGHTING STANDARDS, SIGN POST OR STRUCTURE WHEN RECURRED A LIEBER THE SHIPLY MOUNTED ON LIGHTING STANDARDS, SIGN POST OR STRUCTURE WHEN RECURRED A LIEBER SHOULD FROM THE SHIPLY EXPENSE EXPENSE EXPENSE SHIPLY EXPENSE SHALL RELET SERVICE LITTLY REQUIREMENTS.
- 6. THE LANDING LUG SHALL BE SUITABLE FOR MULTIFLE CONDUCTORS.
- 7. PHOTOELECTRIC CONTROL SHALL BE TYPE II
- B. SERVICE UTILITY WILL INSTALL THE TIME-OF-USE METER IF APPLICABLE.
- 9. UNLESS OTHERWISE NOTED, THE MAXIMUM NUMBER OF SINGLE-POLE CIRCUIT BREAKER SPACES IN THE ENCLOSURE IS FOURTEEN.
- 10. SEE STANDARD PLANS ES-2D FOR OTHER DETAILS

ITEM No.	COMPONENT	NAME PLATE DESCRIPTION	REMARKS
(1)	NEUTRAL LUG		
(2)	LANDING LUG (NOTE 6)		
(3)	TEST BYPASS FACILITY		_
(4)	METER SOCKET AND SUPPORT		
(5)	NUETRAL BUS		
(6)	TERMINAL BLOCK		
7	GROUND BUS		
8	GROUNDING ELECTRODE		
(9)	100 A, 240 V, 2P, CB	MAIN CIRCUIT BREAKER	
10	PHOTOELECTRIC UNIT (SEE NOTE 7)		
(11)	30 A, 240 V, 4P, CB	LIGHTING	
(12)	15 A, 120 V, 1P, CB	LICHTING	
(13)	15 A, 120 V, IP, TEST SWITCH	TEST SWITCH	
(14)	60 A, 2P, NO CONTACTOR		NOT USED
(15)	30 A, 2P, NO CONTACTOR		NOT USED
16)	15 A, 120 V, 1P, CB		NOT USED
17	30 A, 2P, NO CONTACTOR		NOT USED
18	15 A, 120 V, 1P, CB	FLASHING BEACONS	NOT USED
(19)	50 A, 120 V, 1P, CB	SIGNALS	
(20)	20 A, 120 V, 1P, CB	IRRIGATION	NOT USED
(21)	30 A. 120 V. 1P. CB	RAMP METERING	NOT USED
(22)	20 A, 120 V, 1P, CB	TELEPHONE DEMARCATION CABINET	NOT USEC
23	30 A, 120 V, 1P, CB	CCTV	NOT USED
(24)	30 A, 120 V, 1P, CB	TMS	NOT USED
25	30 A, 120 V, 1P, CB	HAR	NOT USED
26	30 A, 120 V, 2P, CB	CMS PANEL	NOT USED
(27)	30 A, 120 V, 1P, CB	CMS CONTROLLER	NOT USEC

#### LEGEND

P	POLE	
CB	CIRCUIT	BREAKER

AMPERE VOLT

METERED UNMETERED SOLID NEUTRAL

NORMALLY OPEN NORWALLY CLOSED - CONDUCTOR OR BUS TIE POINT

— CONDUCTOR COIL
— CONTACTOR, CONTACT NO. S TERMINAL BLOCK
CONTACTOR, CONTACT NO.

ENCLOSURE
GROUND




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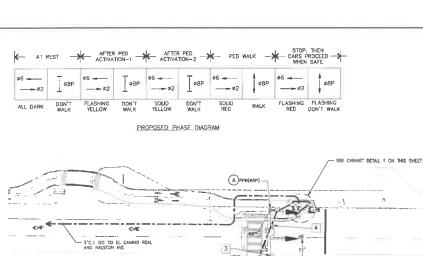
SCALE: AS SHOW SHEET: 11 OF 36


Date: July 6, 2018 Drawn Byc AM f AV Designed Byc AP


RALSTON AVENUE
& ELMER STREET
PEDESTRAN HYBRID BEACON
CONDUCTOR & EQUIPMENT SCHEDULE


DEPARTMENT OF PUBLIC WORKS
RALSTON CORRIDOR IMPROVEMENT PLAN
SEGMENTS 1 & 2
SEGMENT 1 DAIPHOUST 1 DAIPHOUST 2 DAIP



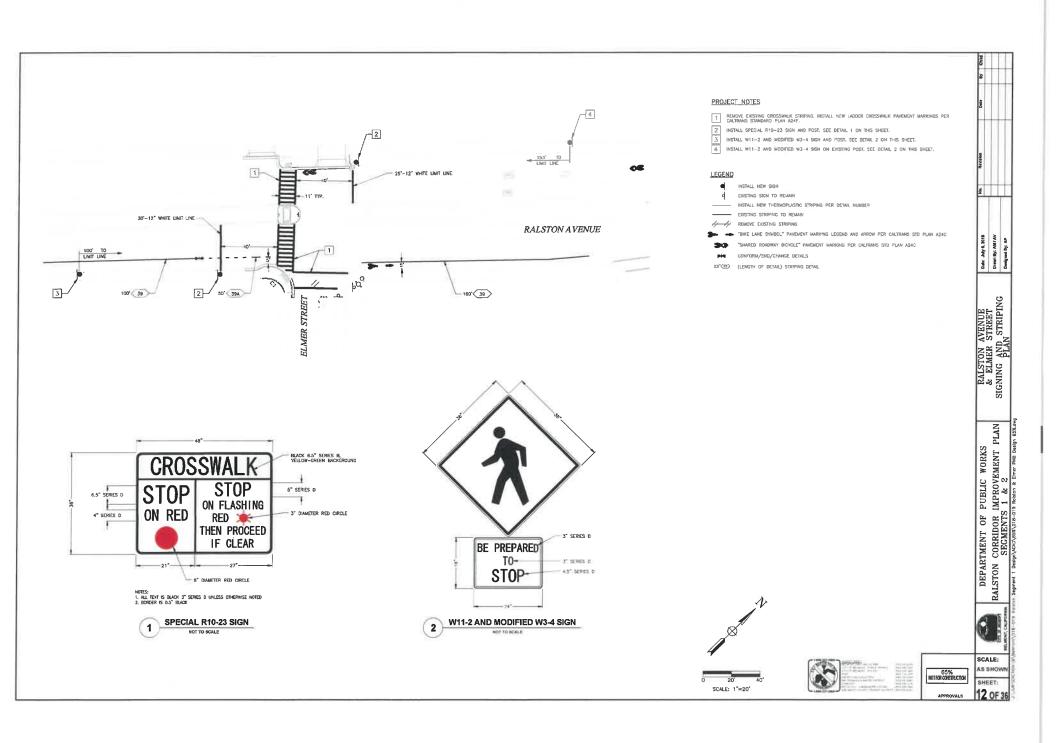

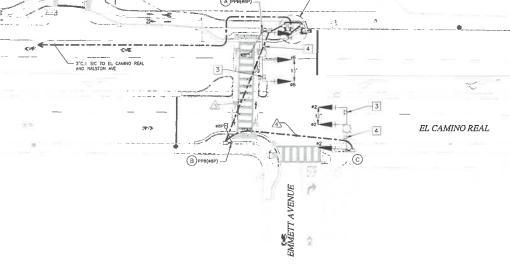

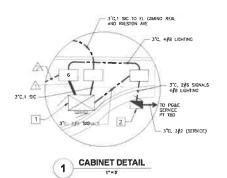


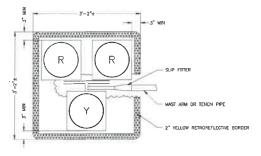

PEDESTRIAN HYBRID BEACON (PHB) DETAIL 2

#### PROJECT NOTES

- FURNISH AND INSTALL TYPE III—AF SERVICE EQUIPMENT ENCLOSURE (120/240V) AND FOUNDATION. SEE WIRING DIAGRAM DETAIL ON SHEET 18.
- 3 MODIFIED R10-23 SIGN. SEE DETAIL 1 ON SHEET 18.
  4 "CROSSWALK" SIGN. SEE DETAIL 2 ON SHEET 18.

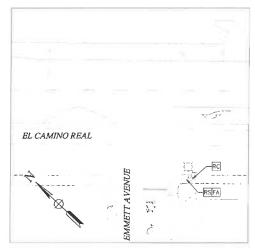

EQUIPMENT REMOVAL PLAN 1" = 20'



SCALE: 1"=20"






EL CAMINO REAL & EMMETT AVENUE PEDESTRIAN HYBRID INSTALLATION

65% NOT FOR CONSTRUCTION

AS SHOWN SHEET: 13 OF 36

	CONDUIT AND CO	DINDOCTOR	JUILLE	OLL				
		NUMBER OF CONDUCTORS  CONDUIT RUN NUMBERS						
AWG OR CABLE	CONDUIT RUN							
ONOLL		1	1	3	4			
	#2	3	3	3	3			
	ø5	3	3					
	ø8P	2	2	2	2			
#14	ØBPPB	1	1	1	1			
	PPB COMMON	1	1	1	1			
	SPARES	3	3	3	3			
	TOTAL #14	13	13	10	10			
	LUMINAIRES		2	2	2			
#8	SIGNAL COMMON		- 1	- 1	1			
go	BOND (BARE)		1	1	1			
	TOTAL #8		4	4	- 4			
		,						
	CONDUIT SIZE (in)	2-3"	3"	3*	3"			
	% CONDUIT FILL	2%	7%	6%	6%			

#### STANDARD NOTES AND ABBREVIATIONS: = NEW CONDUIT RUN

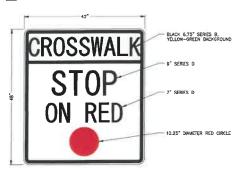





- 1. SIGN SHALL BE DOUBLE FACED USING B INCH UPPERCASE SERIES D LETTERS CENTERED VERTICALLY.
- SIGN SHALL BE A 03-1 PLATE WITH 3/4 INCH BLACK BORDER AND BLACK LETTERING ON YELLOW-GREEN, RETROREFLECTIVE BACKGROUND (TYPE IX RETROREFLECTIVE SHEETING) CONSTRUCTED USING COB INCH GAUGE METAL PLATE.
- MAST ARM MOUNTED STREET NAME SIGNS SHALL BE INSTALLED WITH OVERHEAD MAST ARM ADJUSTABLE SWING SIGN BRACKETS (HAWKINS MIOJ-OCB25CAL).
- REFER TO CALTRAINS STANDARD PLANS FOR MOUNTING DETAILS AND PLACEMENT. THE SIGN BRACKET SMALL BE DOUBLE STRAPPED TO THE MAST ARM WITH HEAVY DUTY STARKESS STEEL STRAPS.
- PROVIDE CITY WILL FULL SIZE PAPER PRINT OF SIGN TO REVIEW AND APPROVE PRIOR TO MANUFACTURING THE SIGN.




MAST ARM MOUNTED "CROSSWALK" SIGN

NOT TO SCALE

						POLE AND	EQUIPM	ENT SCHE	DULÉ	
LOCATION	STANDARD		VEHICLE SIGNAL MOUNTING		PED SIGNAL MOUNTING	PPB		LUMINAIRE LED	SPECIAL REQUIREMENTS	
	TYPE	SIGNAL M.A.	LUM. M.A.	MAST ARM	POLE	MODITING	ø	ø ARROW		
A	24-4-100	35'	15'	MAS MAS	SV-1-T	SP-1-T	ø8	LEFT	63W	INSTALL MODIFIED R10-23 SIGN (DETAIL 1 ON THIS SHEET) AND "CROSSWALK" SIGN (DETAIL 2 ON THIS SHEET) LOCATED ON THE MAST ARM.
B	1-A	-	-	-	-	TP-1-T	ø8	RIGHT	-	
©	19-4-100	30'	15'	MAS MAS	SV-1-T	-	-	-	63W	INSTALL MODIFIED R10-23 SIGN (DETAIL 1 ON THIS SHEET) AND "CROSSWALK" SIGN (DETAIL 2 ON THIS SHEET) LOCATED ON THE MAST ARM.

OTHER REQUIREMENTS ARE COVERED BY NOTES, LEGENDS. SPECIAL PROVISIONS AND STANDARD SPECIFICATIONS, SIGNAL & LIGHTING STANDARDS SHALL CONFORM TO THE MOST RECENT PROVISIONS OF THE CALTRANS STANDARD PLANS. ALL EQUIPMENT SHOWN IN THE SCHEDULE IS NEW UNLESS NOTED OTHERWISE WITH AN (E).

(X) = NEW SIGNAL POLE

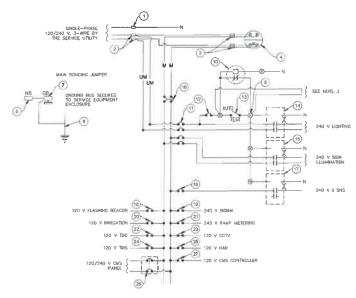

120/240 V SERVICE WIRING DIAGRAM (TYPICAL)

- 1. VOLTAGE RATINGS OF SERVICE EQUIPMENT SHALL CONFORM TO THE SERVICE VOLTAGES INDICATED ON THE PLANS.
- 2. UNLESS OTHERWISE INDICATED ON THE PLANS, SERVICE EQUIPMENT ITEMS SHALL BE PROVIDED FOR EACH SERVICE EQUIPMENT ENCLOSURE AS SHOWN.

  3. CONNECT TO REMOTE TEST SMITCH MOUNTED ON LIGHTING STANDARDS, SIGN POST OR STRUCTURE WHEN REQUIRED.
- 4. ITEMS NO. 1 AND 5 SHALL BE ISOLATED FROM THE SERVICE EQUIPMENT ENCLOSURE.
  5. METER SOCKETS SHALL MEET SERVICE UTILITY REQUIREMENTS.
- THE LANDING LUG SHALL BE SUITABLE FOR MULTIPLE CONDUCTORS
- 7. PHOTOELECTRIC CONTROL SHALL BE TYPE II

  B. SERVICE UTILITY WILL INSTALL THE TIME-OF-USE METER IF APPLICABLE.
- 9. UNLESS OTHERWISE NOTED, THE MAXIMUM NUMBER OF SINGLE-POLE CIRCUIT BREAKER SPACES IN THE ENGLOSURE IS FOURTEEN.
- 10. SEE STANDARD PLANS ES-2D FOR OTHER DETAILS

	TYPE III-A SERVICE EQUI	PMENT ENCLOSURE LEGEND (120/240 V)	
TEM No.	COMPONENT	NAME PLATE DESCRIPTION	REMARKS
(f)	NEUTRAL LUG		
(2)	LANDING LUG (NOTE 6) .		
(3)	TEST BYPASS FACILITY		
(4)	METER SOCKET AND SUPPORT		
(5)	NUETRAL BUS	i .	
(6)	TERMINAL BLOCK		
(7)	GROUND BUS		
8	GROUNDING ELECTRODE		
(9)	100 A, 240 V, 2P, CB	MAIN CIRCUIT BREAKER	
10	PHOTOELECTRIC UNIT (SEE NOTE 7)		
(11)	30 A. 240 V, 4P, CB	LIGHTING	
12)	15 A, 120 V, 1P, CB	LIGHTING	
13)	15 A, 120 V, IP, TEST SWITCH	TEST SWITCH	
14).	60 A, 2P, NO CONTACTOR		NOT USED
(15)	30 A, 2P, NO CONTACTOR		NOT USEE
16)	15 A, 120 V, 1P, CB		NOT USEC
17)	30 A, 2P, NO CONTACTOR		NOT USED
18	15 A, 120 V, 1P, CB	FLASHING BEACONS	NOT USED
19)	50 A, 120 V, 1P, CB	SIGNALS	
20)	20 A, 120 V, 1P, CB	IRRIGATION	NOT USED
21)	30 A, 120 V, 1P, CB	RAMP METERING	NOT USED
22	20 A, 120 V, 1P, CB	TELEPHONE DEMARCATION CABINET	NOT USED
23	30 A, 120 V, 1P, CB	CCTV	NOT USED
24)	30 A, 120 V, 1P, CB	TMS	NOT USED
25)	30 A, 120 V, 1P, CB	HAR	NOT USED
26	30 A, 120 V, 2P, CB	CMS PANEL	NOT USED
27	30 A, 120 V, 1P, CB	CMS CONTROLLER	NOT USED

#### LEGEND

POLE

CIRCUIT BREAKER AMPERE

METERED

UNMETERED

SOLID NEUTRAL NORMALLY OPEN

NORWALLY CLOSED

---- EXTERNAL CONDUCTOR - CONDUCTOR OR BUS - TIE POINT

CONDUCTOR COIL CONTACTOR, CONTACT NO.

ERMINAL BLOCK
CONTACTOR, CONTACT NO.

ENCLOSURE
GROUND




65% NOT FOR CONSTRUCTION


SCALE: AS SHOW SHEET: 14 OF 36

Date: July 6, 2018 Drawn By: AM I AV Designed By: AP

EL CAMINO REAL
& EMMETT AVENUE
PEDESTRIAN HYBRID BEACON
CONDUCTOR & EQUIPMENT SCHEDULE

DEPARTMENT OF PUBLIC WORKS
RALSTON CORRIDOR IMPROVEMENT PLAN
SEGMENTS 1 & 2

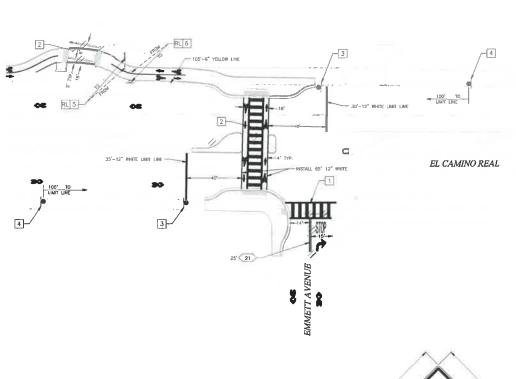

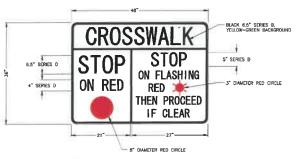

NOTES: 1. ALL TEXT IS BLACK 3" SERIES D UNLESS OTHERWISE MOTED 2. BORDER IS 0.5" BLACK





2 W11-2 AND MODIFIED W3-4 SIGN

#### PROJECT NOTES

1 INSTALL LADDER CROSSWALK PAVEMENT MARKINGS PER CALTRANS STD PLAN AZ4F.

2 INSTALL TRIPLE FOUR AND BASIC CROSSWALK PAVEMENT MARKINGS PER CALTRANS STD PLAN AZ4F WITH DIMENSIONS SHOWN.

INSTALL SPECIAL R10-23 SIGN AND POST, SEE DETAIL 1 ON THIS SHEET.

4 INSTALL W11-2 AND MODIFIED W3-4 SIGN AND POST, SEE DETAIL 2 ON THIS SHEET.

RELOCATE EXISTING "CALTRAIN STATION BELMONT" SIGN AND POST TO LOCATION SHOWN.

RELOCATE EXISTING R28A MODIFIED SIGN AND POST TO LOCATION SHOWN.

#### LEGEND

INSTALL NEW SIGN

EXISTING SIGN TO REMA

INSTALL NEW THERMOPLASTIC STRIPING PER DETAIL NUMBER

EXISTING STRIPING TO READ

REMOVE EXISTING STRIPING

TYPE IV (R) ARROW PAVEMENT MARKING PER CALTRANS STD PLAN A24A

"STOP" PAVEMENT MARKING PER CALTRANS STD PLAN A24D

→ "BIKE LANE SYMBOL" PAVEMENT MARKING LEGEND AND ARROW PER CALTRANS STD PLAN A24C

PEDESTRIAN SYMBOL PAVEMENT MARKING

"SHARED ROADWAY B'CYCLE" PAVEMENT MARKING PER CALTRANS STD PLAN A24C

XX' (LENGTH OF DETAIL) STRIPING DETAIL









EL CAMINO REAL
& EMMETT AVENUE
SIGNING AND STRIPING
PLAN

DEPARTMENT OF PUBLIC WORKS
RAISTON CORRIDOR IMPROVEMENT PLAN
SEGMENTS 1 & 2
SEGMENTS 1 & 2
SEGMENT DESPIVED/SERVICE-019 6 Coming Ray & Demost 1 Fill Despi

R REMONT, CALIFORNIA

SCALE: AS SHOWN SHEET: 15 OF 36

SCALE: AS SHOWN
SHEET:
16 OF 36

65% NOT FOR CONSTRUCTION

BEFORE EXCAVATING
CALL U.S.A.
UNDERCROUND SERVICE ALERT
800—227—2500
TWO WORKING DAYS BEFORE ALL
PLANNED WORK OPERATIONS

DEPARTMENT OF PUBLIC WORKS

CORRIDOR IMPROVEMENT PLAN SEGMENTS 1 & 2 Progreem 1 Design/ACAD/85X/D18-D19 Rainton Segment 1 Design EEX.cheq

ELECTRICAL DETAILS

Date: April 17, 2018 Drawn By: AM Designed By: AP

LOCATION MAP

BENCHMARK/DATUM

SEE CIVIL IMPROVEMENTS PLAN FOR TEMPORARY CONTROL POINT LOCATIONS.

### RECORD DRAWINGS

CONTRACTOR SHALL KEEP ACCURATE RECORD DRAWINGS WHICH SHOW THE FINAL LOCATION, ELEVATION, AND DESCRIPTION OF ALL WORK, CONTRACTOR SHALL ALSO NOTE THE LOCATION, AND DESCRIPTION OF ALL WORK, CONTRACTOR SHALL ALSO NOTE THE LOCATION AND ELEVATION OF ANY PERSON IMPROVEMENTS SHOULD REPORT SHALL BE TREDUCED ON A SET OF CONSTRUCTION PLAN DRAWINGS AND GIVEN TO THE OWNER UP OF WORK.

UNAUTHORIZED CHANGES

THE ENGINEER PREPARING THESE PLANS WILL NOT BE RESPONSIBLE FOR, OR LIABLE FOR UNAUTHORIZED CHANGES TO OR USES OF THESE PLANS WILL NOT BE RESPONSIBLE FOR, OR LIABLE FOR UNAUTHORIZED CHANGES TO OR USES OF THESE PLANS WILL CHANGES TO THESE PLANS MUST BE IN WRITING AND MUST BE APPROVED BY WILSEY HAM.

ALL REVISIONS TO THESE PLANS MUST BE REVIEWED AND APPROVED IN WRITING BY WILSEY HAM AND THE CITY ENGINEER PRIOR TO CONSTRUCTION OF AFFECTED ITEMS. IN ADDITION, REVISIONS AFFECTING THE WATER SYSTEM ALSO REQUIRE WRITTEN APPROVAL FROM MID-PENINSULA WATER DISTRICT PRIOR TO CONSTRUCTION OF THE AFFECTED ITEMS.

### **ACCURACY**

AS TO THE ACCURACY SETWEEN THE WORK SET FORTH ON THESE PLANS AND THE WORK IN THE FIELD, ANY DISCREPANCES SHALL BE BROUGHT TO THE ATTENTION OF WILSEY HAM PRIOR TO START OF CONSTRUCTION OF THE PARTICULAR ITEM OF WORK.

### ACCURACY OF UTILITIES

EXISTING UTILITY INFORMATION WAS PROVIDED TO WILSEY HAM AND MAY NOT HAVE SEEN VERIFIED IN THE FIELD, CONTRACTOR SHALL VERY FALL UTILITY LOCATIONS AND REPORT ANY CONFLICTS TO THE ENGINEER SEFORCE CONSTRUCTION SEGNS.

EXISTING	PROPOSED		EXISTING	PROPOSED	
		CENTERLINE	<b>©</b>	030	*CATCH BASIN
		PARCEL LINE/RIGHT OF WAY	•	•	STORM DRAIN MANHOLE
		BUILDING LINE	~-O~	~	SIGN
		CONCRETE SIDEWALK	»)ģ(-		ELECTROLIER
		CURB AND GUTTER	sAg.		GAS VALVE
	7 4 16.4		B		FIRE HYDRANT
		DRIVEWAY	日		WATER METER
		LIMIT OF SLURRY SEAL	A		WATER VALVE
	<del>_x_x_x</del> _	FENCE			SLURRY SEAL LIMITS
		CONTOUR			
		VALLEY GUTTER			DIGOUT REPAIR
		SANITARY SEWER		~~	CONTRACTOR SHALL
		STORM DRAIN			GRADE TO DRAIN
the-		WATER	$\odot$		TREE
- 451E		ELECTRIC LINE	$\stackrel{\sim}{\sim}$		
104		GAS	$\oplus$		TREE TO BE REMOVED
_		MONUMENT	<del>(D)</del>		STUMP TO BE REMOVED
0	18 .	GROUND SLOPE	~		
0	-1/9	SANITARY SEWER MANHOLE		$\overline{}$	RETAINING WALL

**LEGEND** 

(§)

### ABBREVIATIONS

ARRHEA	IATIONS		
AB	AGGREGATE BASE	МН	MANHOLE
AC	ASPHALT CONCRETE	MON	MONUMENT
BC	BEGINNING OF CURVE	(N)	NEW
BM	BENCHMARK	N	NORTH
BR	BOTTOM OF RAMP	NTS	NOT TO SCALE
BVC	BEGINNING OF VERTICAL CURVE	(P)	PROPOSED
BW	BACK OF WALK	PCC	PORTLAND CEMENT CONCRETE
C&G	CURB AND GUTTER	PL	PROPERTY LINE
CB	CATCH BASIN	PRVC	POINT OF REVERSE VERTICAL CURVATURE
CL	CENTERLINE	R	RADIUS
CLR	CLEAR -	R/W	RIGHT OF WAY
COM	COMMERCIAL	RET	RETURN
CP	CONTROL POINT	RT	RIGHT
DÉT	DETAIL	S	SOUTH, SLOPE
DI	DROP INLET	SD	STORM DRAIN
DG	DECOMPOSED GRANITE	SDCB	STORM DRAIN CATCH BASIN
DWY	DRIVEWAY	SDDI	STORM DRAIN DROP INLET
E	EAST	SDMH	STORM DRAIN MANHOLE
ELEC	ELECTRICAL	SL	STREET LIGHT
EC	END OF CURVE	SS	SANITARY SEWER
EG	EXISTING GROUND	SSMH	SANITARY SEWER MANHOLE
EL, ELEV	ELEVATION	STA	STATION
EP	EDGE OF PAVEMENT	STD	STANDARD
EVC	END OF VERTICAL CURVE	SW	SIDEWALK
(E), EX	EXISTING	TBR	TO BE RELOCATED
FC	FACE OF CURB	TC	TOP OF CURB
FG	FINISH GRADE	TDC	TOP OF DEPRESSED CURB
FH	FIRE HYDRANT	TG	TOP OF GRATE
FL	FLOW LINE	TR	TOP OF RAMP
FP	FINISHED PAVEMENT	TRC	TOP OF ROLLED CURB
FT	FOOT OR FEET	TYP	TYPICAL.
G	GAS	VC	VERTICAL CURVE
GB	GRADE BREAK	VG	VALLEY GUTTER
HP	HIGH POINT	W	WATER, WEST
INV	INVERT ELEVATION	WW	WATER METER
JT	JOINT TRENCH	WV	WATER VALVE
L	LENGTH		
LIF.	LINEAR FOOT/FEET		
LT	LEFT		
LP	LOW POINT		

DEPARTMENT OF PUBLIC WORKS CORRIDOR IMPROVEMENT PLAN SEGMENT 1 & 2

CHAd A 25

Revision 66% DESIGN SUBMITTAL

ABBREVIATIONS

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LEGEND

WILSEY # HAM


3130 La Selva Street, Sulta 100 San Mateo, CA 94403 650,349,2151 wilseyham,com





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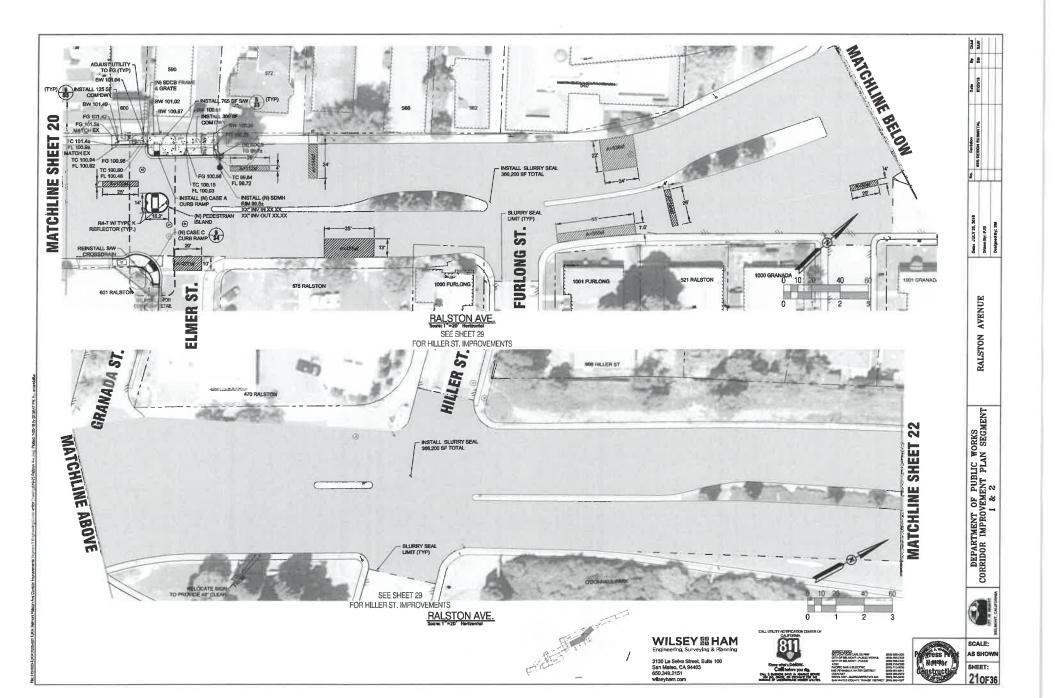



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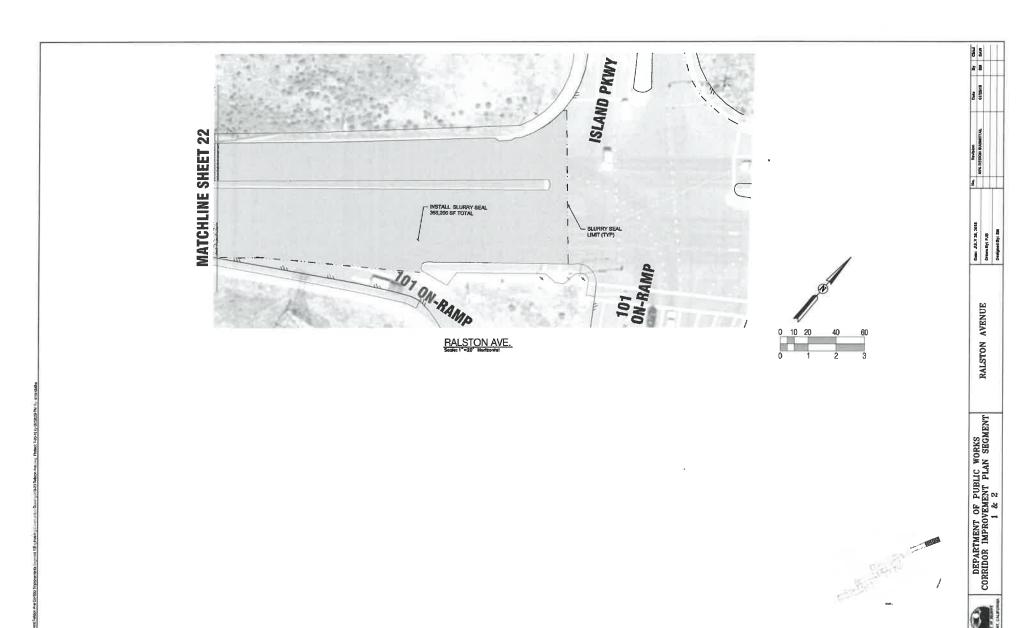




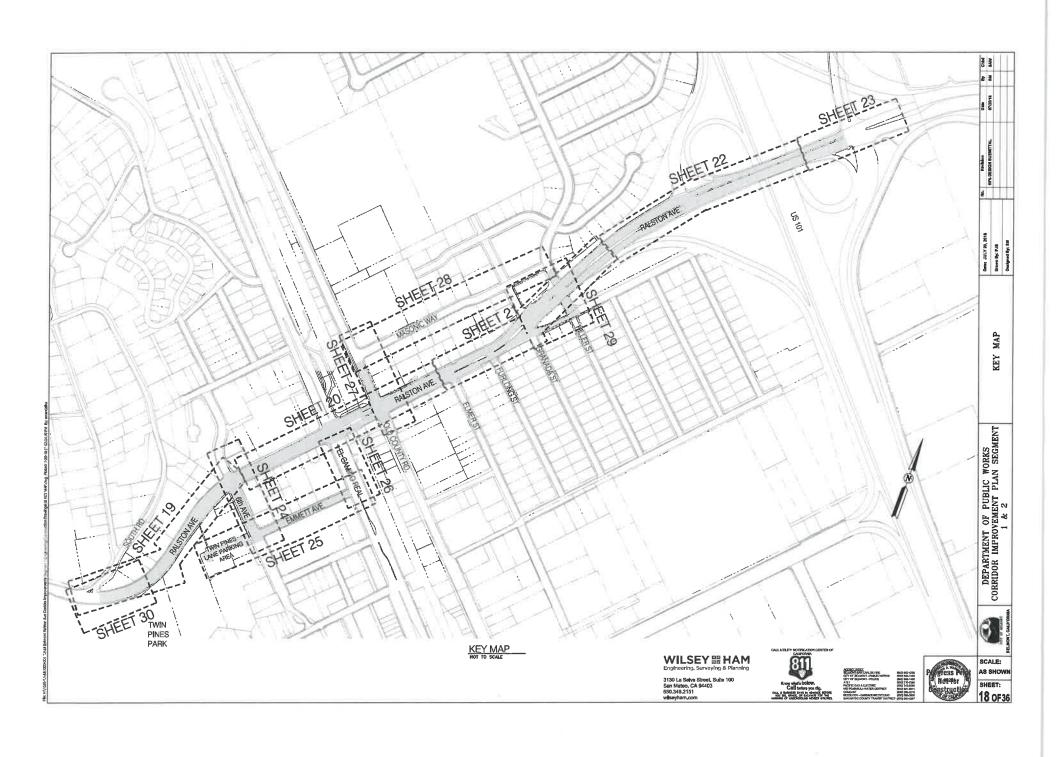

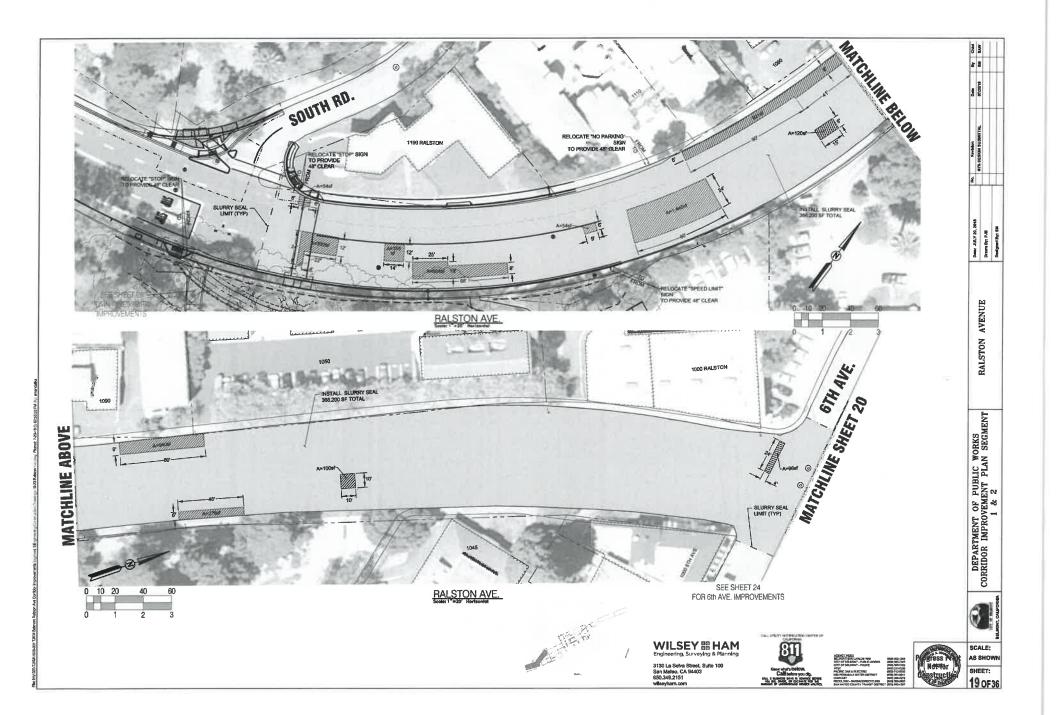

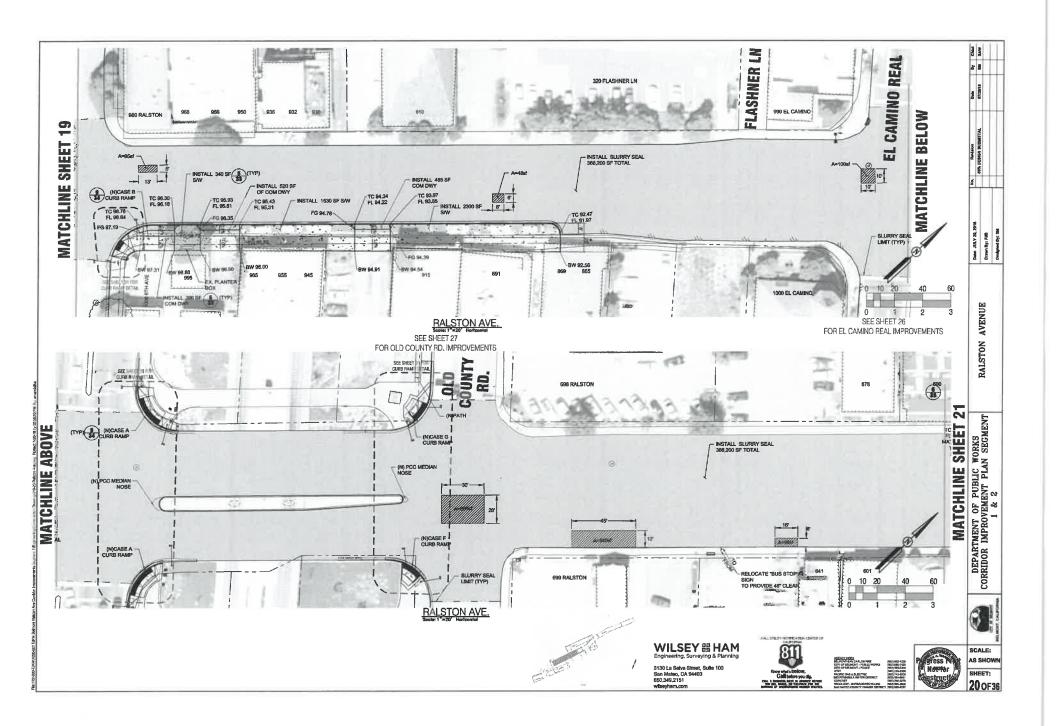

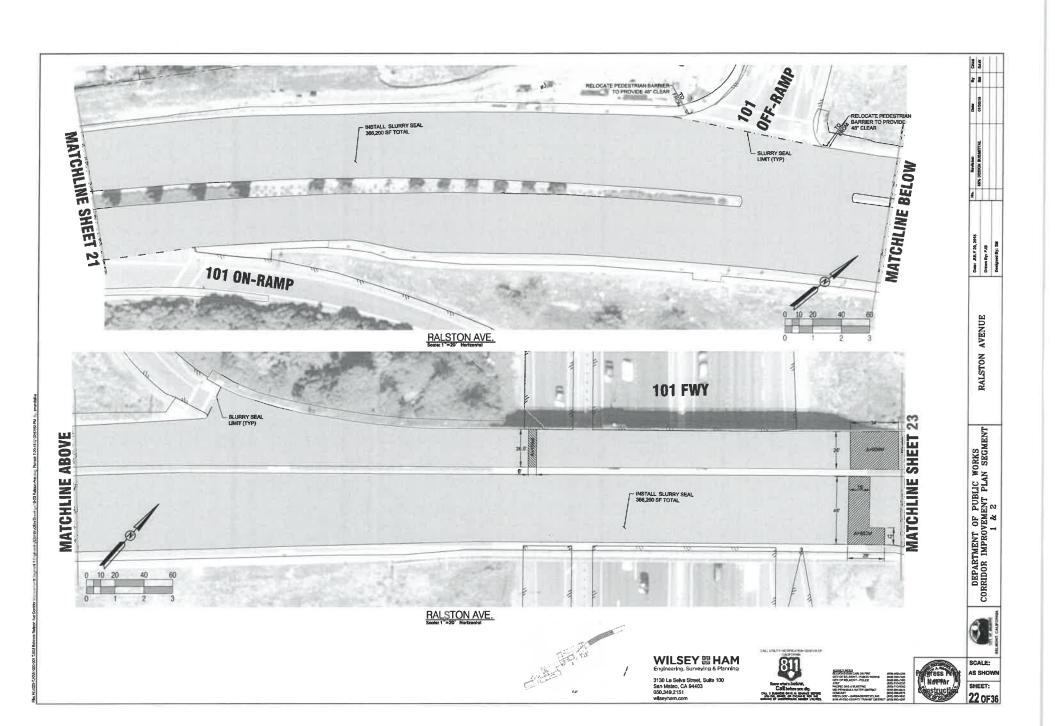

WILSEY BE HAM Englneering, Surveying & Planning


3130 La Selva Street, Suite 100 San Mateo, CA 94403 650,349,2151 wilesyham.com










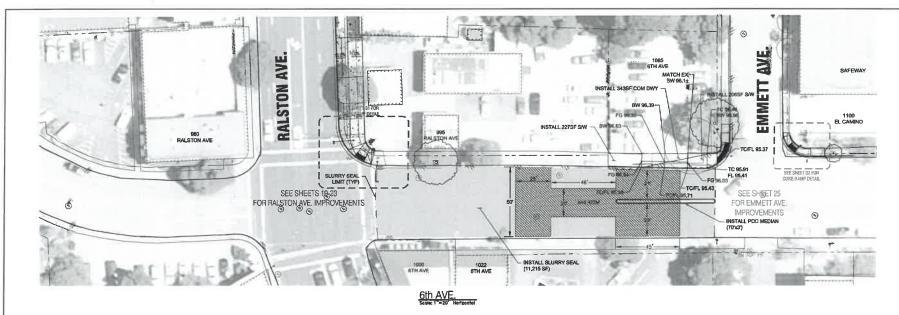

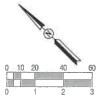





By Child

Date: JULY 20, 2018 Drawn Byr P48 Deelgned By; Sus

6th AVE.


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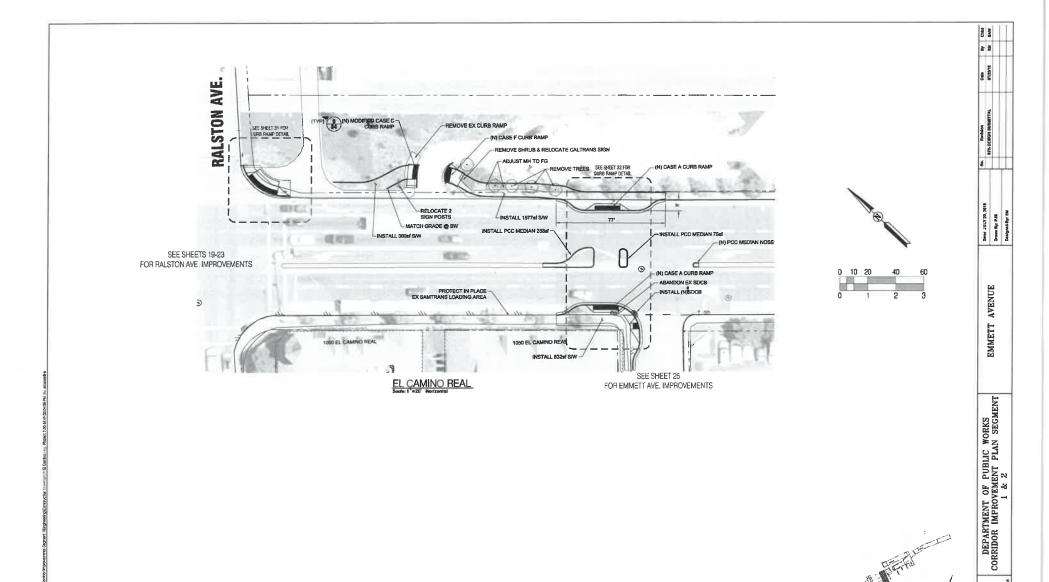
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SCALE: AS SHOWN SHEET: 24 OF 36





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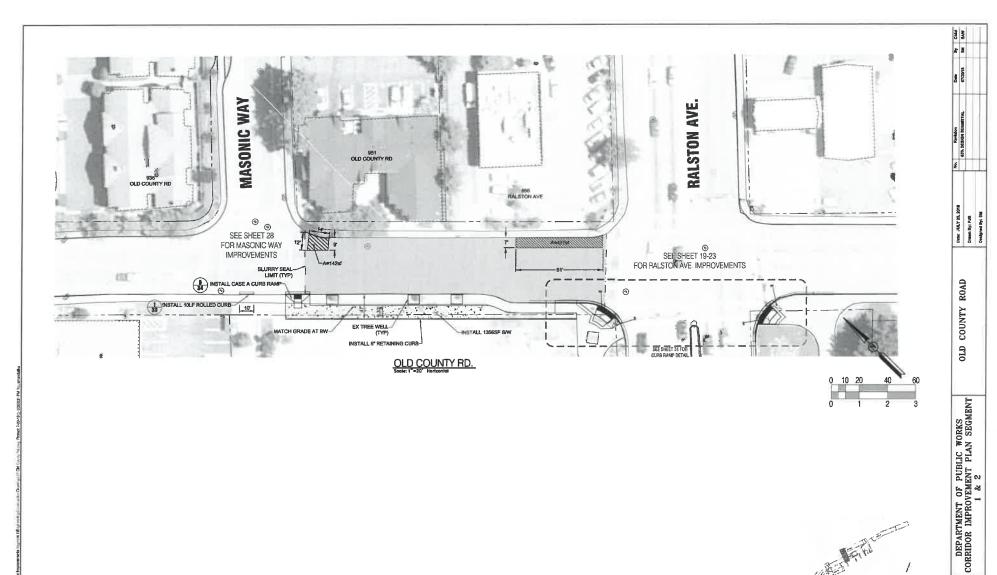
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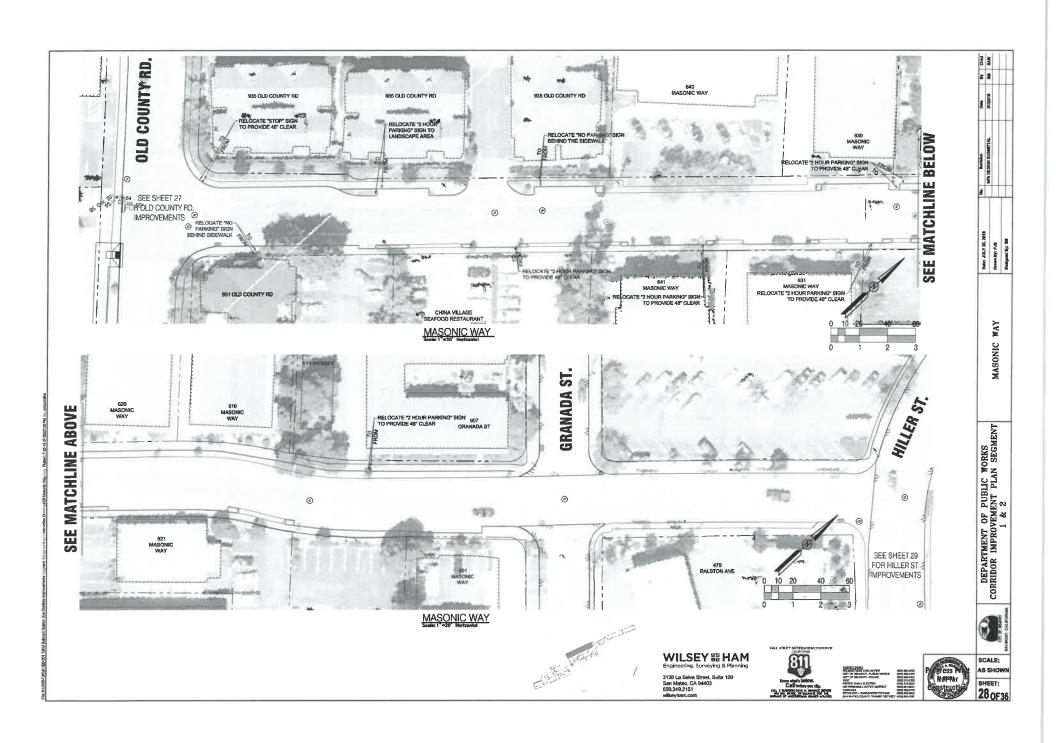
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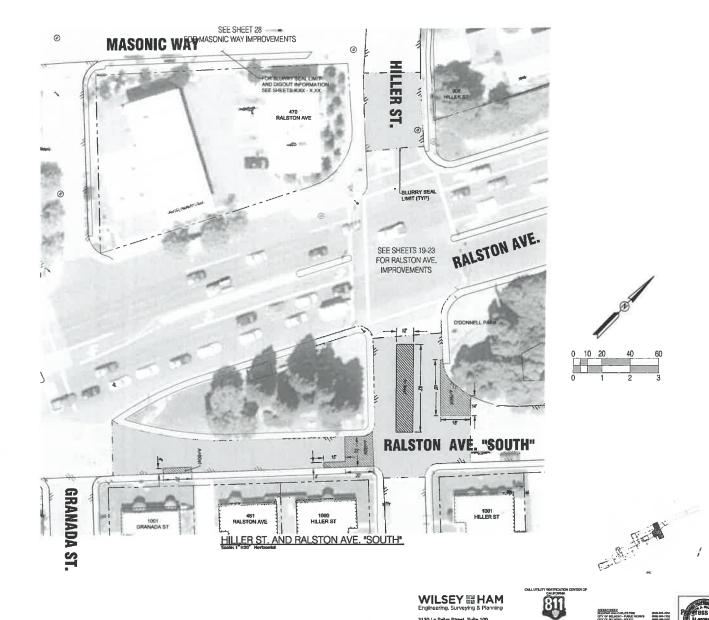




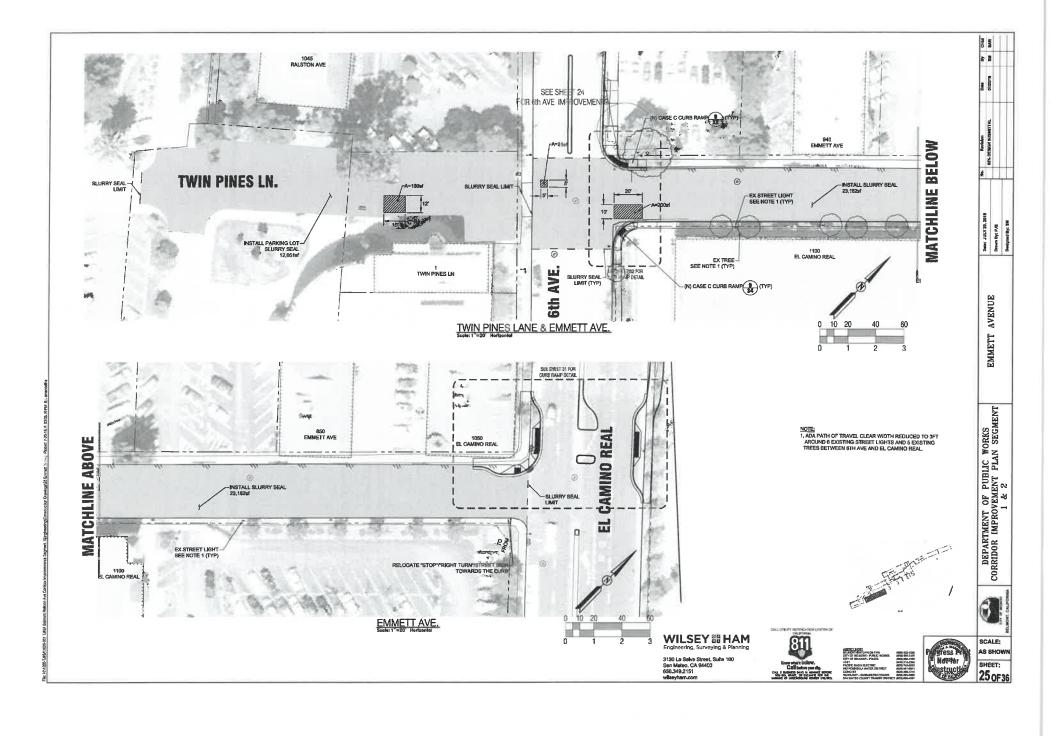







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Know where below.
Call before you dig.
Call a seed on streets street
100 bit, which of County First bit.
Mentally of selectable streets or streets.

Child 2 2

HILLER STREET AND RALSTON AVENUE "SOUTH"


DEPARTMENT OF PUBLIC WORKS
CORRIDOR IMPROVEMENT PLAN SEGMENT
1 & 2





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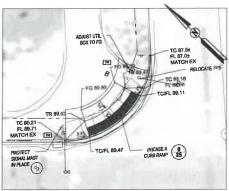




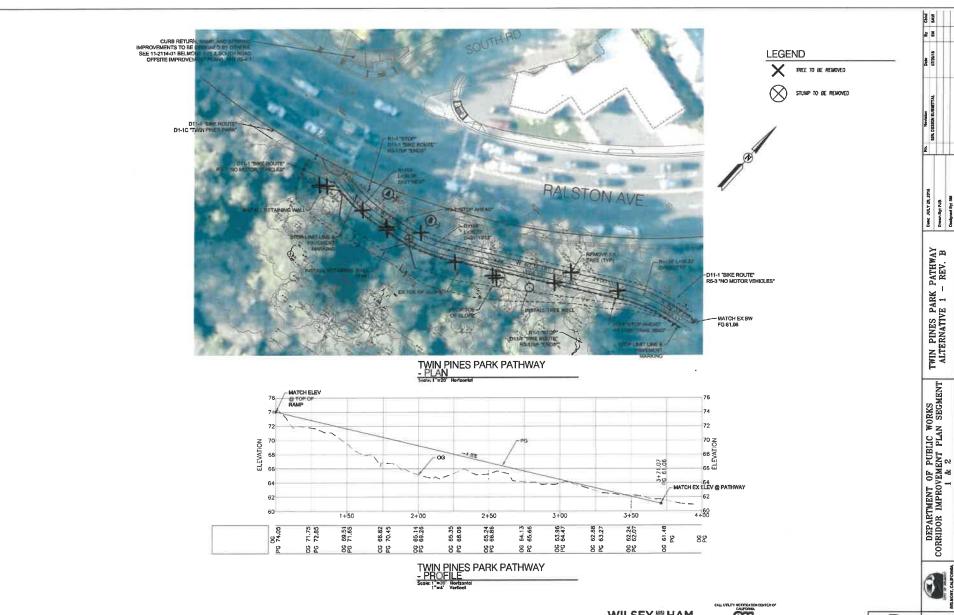


SCALE: AS SHOW SHEET: 30 OF36

RALSTON AVE & 6TH AVENUE - SE CORNER




RALSTON AVE & EL CAMINO REAL - NE CORNER

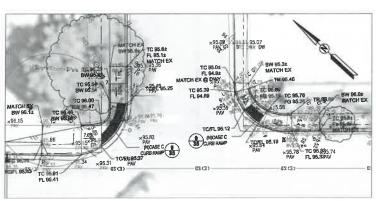


6TH AVE & EMMETT ST. - NE CORNER

### NOTES

- ANY SURFACE UTILITIES, SUCH AS MANHOLES, VALVES, MONUMENTS, DRAIN INLETS, DETECTOR HANDHOLES AND UTILITY BOXES SHOWN TO BE WITHIN CONSTRUCTION LIMITS SHALL BE ADJUSTED IN ELEVATION TO MATCH THE FINISHED GRADE. UTILITY COVERS SHALL NOT BE STRIPED OVER.
- 2. SIGNAGE, STRIPING, AND PAVEMENT MARKINGS SHALL CONFORM TO CURRENT CALTRANS STANDARD SPECIFICATIONS AND STANDARD PLANS AND TO THE CALIFORNIA MANUAL ON UNIFORM TRAFFIC CONTROL DEVICES (CA
- 3. ALL TRAFFIC STRIPES AND PAVEMENT MARKINGS SHALL BE THERMOPLASTIC ANDCOMPORM TO SECTION 84 OF THE CALTRANS STANDARDS SPECIFICATIONS.
- CROSSWALKS, STOP BARS, AND LEGENDS SHALL CONFORM TO CALTRANS STANDARD PLANS A24D AND A24E.
- 5. ALL EXISTING SIGNAGE SHALL REMAIN IN PLACE.
- 6. PROTECT AND/OR REPLACE ALL SURVEY MONUMENTS LOCATED IN WORK AREA.

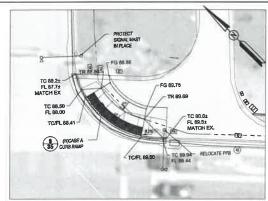

RALSTON AVE & EL CAMINO REAL - SE CORNER

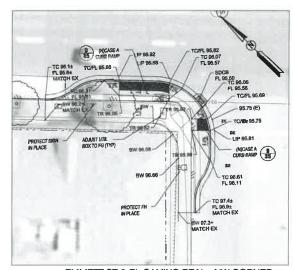

EMMETT ST & EL CAMINO REAL - NW CORNER



WILSEY B HAM

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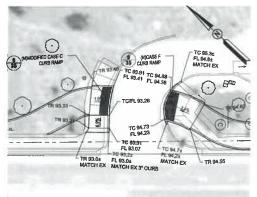
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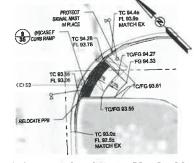
SAW SAW 8 3

Drawn By: PJB Drawn By: PJB Designed By: SNI

AVENUE


RALSTON





EL CAMINO REAL - CALTRANS PARKING ENTRY

RALSTON AVE & OLD COUNTY RD. - SW CORNER

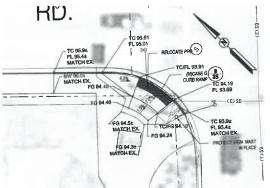

**RALSTON AVE & OLD COUNTY RD. - NW CORNER** 



#### NOTES

- ANY SURFACE UTILITIES, SUCH AS MANHOLES, VALVES, MONUMENTS, DRAIN INLETS, DETECTOR HANDHOLES AND UTILITY BOXES SHOWN TO BE WITHIN CONSTRUCTION LIMITS SHALL BE ADJUSTED IN ELEVATION TO MATCH THE FINISHED GRADE. UTILITY COVERS SHALL NOT BE STRIPED OVER.
- Skonage, Striping, and Pavement Markings Shall conform to current caltrans Standard Specifications and Standard Plans and to the California Manual on Uniform Traffic Control Devices (CA
- ALL TRAFFIC STRIPES AND PAVEMENT MARKINGS SHALL BE THERMOPLASTIC ANDCONFORM TO SECTION 84 OF THE CALTRANS STANDARDS SPECIFICATIONS.
- CROSSWALKS, STOP BARS, AND LEGENDS SHALL CONFORM TO CALTRANS STANDARD PLANS A24D AND A24E.
- 5. ALL EXISTING SIGNAGE SHALL REMAIN IN PLACE.
- 6. PROTECT AND/OR REPLACE ALL SURVEY MONUMENTS LOCATED IN WORK AREA.

WILSEY B HAM Engineering, Surveying & Planning

3130 La Selva Street, Suite 100 San Mateo, CA 94403 650.349.2151 witasyham.com






SCALE; AS SHOWN SHEET: 32 OF 36

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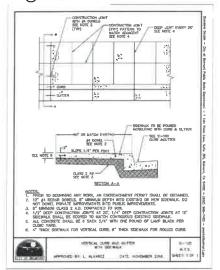
Dates JULY 20, 2018 Drawn By: PJB Designed By: 816

AVENUE


RALSTON

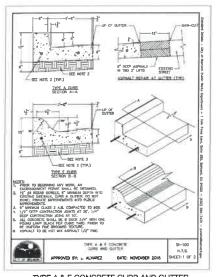


## TYPE A & E CONCRETE CURB AND GUTTER CITY STANDARD DETAIL SI-100



VERTICAL CURB AND GUTTER W/ SIDEWALK (5) CITY STANDARD DETAIL SI-105

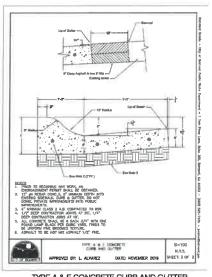

## TYPE A & E CONCRETE CURB AND GUTTER

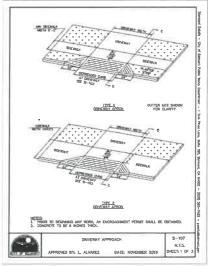

DRIVEWAY APPROACH
CITY STANDARD DETAIL SI-107

# TYPE A & E CONCRETE THRU CURB DRAIN 3 STYN SERI

DATE: NOVEMBER 2016

TYPE A & E CONCRETE THRU CURB DRAIN

1.35

STREET

SI-101 NLT.S.

SHEET: 1 OF 2

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SEE MOTE 2 (TYP.)
TYPE A CURB
SECTION A-A

/ .

SECTION B-B

SCHOOL B-D

SCHOOL TO ECONOMIST OF SORTH AND THE SCHOOL TO ECONOMIST PROPER SOUL EX COSTINGO.

TO COLLECTE TO ECONOMIST PROPER SOUL EX COSTINGO.

If I AP READ ROUGHT SOUL EX COSTINGO.

TO A PROVIDE SOUR EXPENDED THE STOP PARKET SOUR COSTINGO AND THE SOUR EXPENDED THE SOUR EXPENDED TO ECONOMIST PROPERTY SOUR EXPENDED TO ECONOMIST SOUR EXPENDED TO ECONOMIST SOUR EXPENDED TO A PARKET SOUR EXPENDED TO ECONOMIST SOUR EXPENDED TO A PARKET SOUR EXPENDED TO ECONOMIST SOUR EXPENSIVE SOUR EX


E-GOMEER APPROVAL.

8. ASPHALT TO BE HOT MIX ASPHALT 1/2" FINE.

9. UNLESS CTHERWISE NOTED, ALL RADE TO BE 1/2"

SEE MOTE 3 SEE WOTE S


APPROVED BY: L. ALVAREZ

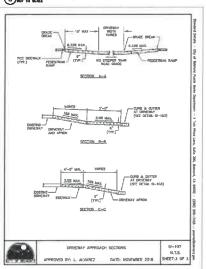


# DRIVEWAY APPROACH SECTIONS OF THE SEALE

## WILSEY 間 HAM

3130 LD SDIID S@DDIDSDIID 100 SDDMCDb0CA 94403 650.349,2151 CONTOCORDO DA DE

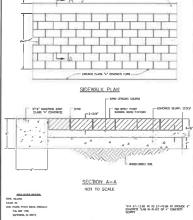

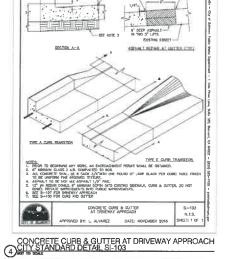

Definition of the
SIDEWALK PLAN
(COA)4. SA, CONCLOSE THEN PARD TO SECURE STREET CONCLOSES STREET STREET, SCO.)4.
PRESIDENCE DOX
SECTION A-A

BACK OF WALK FOR CONCRETE BOWDER, IT DEEP VENERALD PLANE JOHN'S AS NO OC OR AS MAYORING

8 SIDEWALK PAVER DETAIL

SIDEWALK DETAIL FOR THE COMMERCIAL AREAS WITHIN THE REDEVELOPMENT DISTRICT



offy of manage

ACREMY BREN.
BERNATI CAN CARLOT FRE
CHYO'RD WART - PRILET WORKS

AND PROPERTY - PRILET WORKS

BECOND'S TO SHOW BRENCH - PRILET WORKS

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BECOND'S TO SHOW BRENCH - PRILET WARR FOR THE PRILET WORKS

BEN MATED DOWN'T PRIMARY COPINET (900) 800-331



SCALE: A8 SHOWN SHEET: 33<sub>0F36</sub>

DEPARTMENT OF PUBLIC WORKS CORRIDOR IMPROVEMENT PLAN SEGMENT 1 & 2

SAW SAW 4 3

65% DESIGN BUSINITTAL

Date: JULY 20, 2 Onem By: PJB Designed By: 3M



DEPARTMENT OF PUBLIC WORKS
CORRIDOR IMPROVEMENT PLAN SEGMENT
1 & 2

Debts: JULY 20, 2018 Drawn By: PJB Designed By: 846

DETAILS

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SECTION



SCALE: AS SHOWN SHEET: 34 OF 36

WILSEY 歸 HAM

3130 LD SEITH SHORTISETH 100 SEI MORIBUCA 94403



1950) 902-4255 19505 595-7425 19505 595-7425 19605 245-7400 18006 215-2355 18007 743-5000 18007 246-2278 18007 246-2278 18007 885-4367 27 18007 885-4367 SELMONT-SAV CARLOS PIRE CITY OF BELMONT - PURELE WORKS CITY OF BELMONT - POLICE



MAJON BY CRADE

2-#4 DOWELS AT 2' O.C., 12" LONG, EMBEDDED 6" DRUL RATO EX. AND EPOXY

2-#4 DOWELS CURB AND GUTTER, 12" LONG, EMBEDDED 6" DRILL INTO EX, AND EPOXY

RETAINING CURB IT NECESSARY AT EDGE OF SIDEWALD

NOTE 9

- 1 B.

PHERE A PLANED SIDE OCCURS. PREPARE 2'-0" Min OF CURS. ...

CASE E

CASE B

9.0% Mon AT CURB

9 DS: Mos AT CURB

CASE A

CASE D

DETAIL A TYPICAL TWO-RAMP CORNER INSTALLATION

SEE MONE B

FRONT EDGE OF SIDEWALK

(9) CALTRANS CURB RAMP DETAILS

CASE C

FLORING TOP OF RAMP A'-2" NH.

SECTION A~A

PETABLONG CLIPS IF NECESSAPT

4'-2" Min 7.57 Ho.

SECTION B-B

SECTION CHC

ROUNDED TO THE

PETAMING CUPB IF NECESSARY LSV Vot

7.58 Mg 1.58 Mgs

CASE F

0.45° MN RNO 0.47° Mgs H I+ 1

BASSED TRUNCATED DOME

8.0% Max

J. As alter conditions dictots, Coss A through Coss C curb memos may be used for corner installations similar to those shown in Datall 4 and Detail 8 the case of curb memos used in Datall 4 on on how to be the some. Cose A through Coss C curb memos size on may be used of mid-blook foodings. Se also conditioned electate.

Mere ramp is located in center of ourb return, cross-with configuration must be similar to that shows for Datell II.

As site conditions dictale, the relability curb side and the flored side of the Case G name and be constructed in revened position

If located on a starks, the sites of the romp figed not be perallel, but the reinforum width of the romp shall be 4~2".

Sidnestik and remp thickness. "1", shall be 51/2" minimum

LUBBly pull bows, merholes, vestis and all other wilety facilities within the boundaries of the curb remp will be velocated or adjusted to grads by the owner prior he, or in conjunction with curb ramp correlated.

25 No No 25 40 25 40 0 0 0 0 0 0

Detectable earning surface may have to be cut to oliow removal of utility covers units maintaining full detectable earning eligits and depth.

RAISED TRUNCATED DOME PATIERN (IN-LINE)
DETECTABLE WARNING SURFACE

STATE OF CALIFORNIA DEPARTMENT OF TRANSPORTATION

RSP ABBA DANED JALY 15, 2016 SEPERSTERS STANDARD FRANK ABBL D DORDBER JO, 2016 — PYDE 127 OF THE STANDARD PLANE BOOK DATED 2

REVISED STANDARD PLAN RSP A88A

CURB RAMP DETAILS

Side stops of romp Saves vary uniformly from a movinsen of 9.000 of out to centern with longitudinal storacilit slope adjacent to top of the sense, artispt in Case C and Case F. The adjacent europea at transitions at earls ramps to make, guilters, and streets shall be at the same level.

A TWIN PINES PARK PATHWAY SECTION

10 SIGN POST DETAIL

4. SIGNS SHALL BE INSTALLED AT BACK OF SIDEWALK UNLESS OTHERWISE SHOWN ON THE PLANS,  $% \left( 1\right) =\left( 1\right) ^{2}$ 5. THE EDGE OF SIGN SHALL BE EVEN WITH THE BACK OF WALK AND NOT ENCROACH INTO THE SIDEWALK.

2½ X2½, 12 GA SLEEVE



METAL POSTS SHALL BE TELESPAR SQUARE TUBING OR APPROVED EQUAL. SIGN POST MUST BE BREAKAWAY.


AT INSTALLATION COVER HOLES BELOW CONCRETE WITH TAPE TOO PREVENT CONCRETE FROM FALLING INTO SLEEVE AND ANCHOR.

3. SIGN HEIGHT SHALL BE 7" FROM BOTTOM OF SIGN TO THE GROUND SURFACE.

-GROUND SURFACE

12" CONCRETE BASE, CLASS B



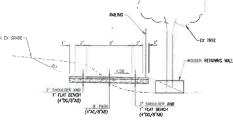


TWIN PINES PARK PATHWAY SECTION BWITH RETAINING WALL


REMOVE AND DISPOSE THE TOP 6" OF THE ROAD SECTION. THE 6" HAM SECTION SHALL CONTAIN §" MAX AGGREGATE.
 EX. SUBCRADE SHALL BE SCARRIED, MOISTURE CONDITIONED AND COMPACTED TO 95% RELATIVE DENSITY.


11 DOWEL DETAIL

12 DIGOUT REPAIR DETAIL


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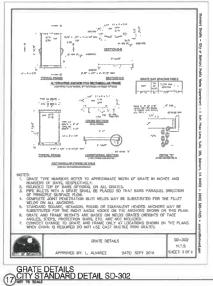


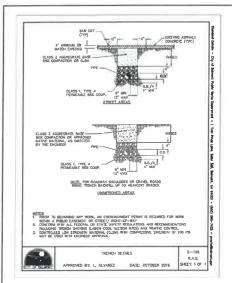

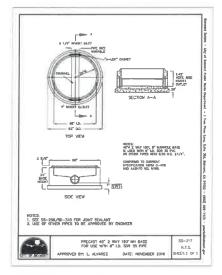


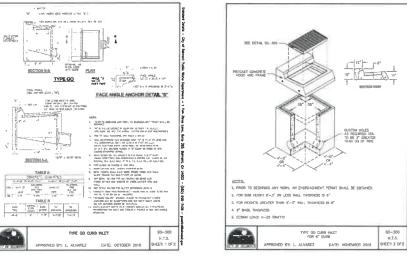



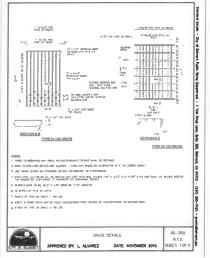

GME.

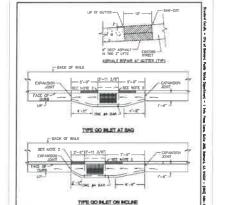


PRECAST CONCRETE STRUCTURES ARE ACCEPTABLE, US CONCRETE OR APPROVED EQUAL.
 TRANSITION FROM CURB & GUTTER TO ROLLED CURB WITHIN A MINIMUM OF 30"



TYPE GO CURB INLET

## TYPE GO CURB INLET CITY STANDARD DETAIL SD-300

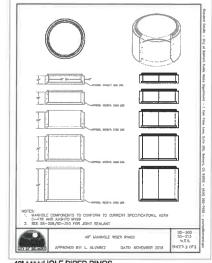

48' MANHOLE RISER RINGS 19 1 STANDARD DETAIL SD-305

3130 LD SCHID SCHOOL SCHID 100 SDD MCDb-DCA 94403 650.349.2151 രണന്തെ.രംവ







SCALE: AS SHOWN SHEET: 35 of 36

Engineering, Surveying & Planning

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Date: JULY 20, 2018 Drewn By: PJB Designed By: 8M

DETAILS

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SECTION


DEPARTMENT OF PUBLIC WORKS CORRIDOR IMPROVEMENT PLAN SEGMENT 1 & 2

GRATE DETAILS (16 CITY STANDARD DETAIL SD-302


WILSEY 器 HAM

SD-303 N.T.S.



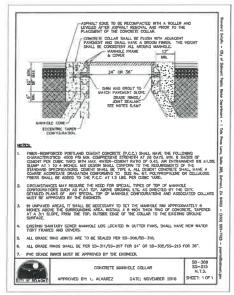



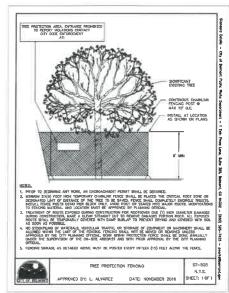

TREE PROTECTION FENCING
OUT STANDARD DETAIL ST-503

DEPARTMENT OF PUBLIC WORKS CORRIDOR IMPROVEMENT PLAN SEGMENT 1 & 2

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Date: JULY 20, 2018 Orewn By: PJ8 Detigned By: SM

DETAILS



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(8099 PG2-4275 (899) 595-7425 (800) 545-7400 (800) 215-755 (800) 743-5000 (450) 595-894 1 (850) 595-8900 (77 (800) 995-4287 (850) 995-4287



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